EAST END STAGE 3 & 4 HUNTER, MORGAN, NEWCOMEN, KING STREETS, NEWCASTLE NSW 2300



LOCALITY PLAN IMAGE FROM SIXMAPS 16.02.2022

	DRAWING SCHEDULE
Sheet Number	Sheet Title
C000	COVER PAGE
C005	GENERAL ARRANGEMENT PLAN
C100	STORMWATER MANAGEMENT PLAN STAGE 3 BASEMENT 03
C101	STORMWATER MANAGEMENT PLAN STAGE 3 BASEMENT 02
C102	STORMWATER MANAGEMENT PLAN STAGE 3 BASEMENT 01
C103	STORMWATER MANAGEMENT PLAN STAGE 3 GROUNDFLOOR PLAN
C104	STORMWATER MANAGEMENT PLAN STAGE 4S BASEMENT 03
C105	STORMWATER MANAGEMENT PLAN STAGE 4S BASEMENT 02 AND 4N GROUND
C106	STORMWATER MANAGEMENT PLAN STAGE 4S BASEMENT 01 AND 4N LEVEL 1
C107	STORMWATER MANAGEMENT PLAN STAGE 4S LOWER GROUND

C108	STORMWATER MANAGEMENT PLAN STAGE 4S UPPER GROUND
C170	MUSIC CATCHMENT PLAN STAGE 3
C171	MUSIC CATCHMENT PLAN STAGE 4N
C172	MUSIC CATCHMENT PLAN STAGE 4S
C200	STORMWATER DETAILS SHEET 01
C201	STORMWATER DETAILS SHEET 02
C202	STORMWATER DETAILS SHEET 03
C320	SEDIMENT & EROSION CONTROL PLAN
C350	SEDIMENT & EROSION CONTROL DETAILS



FOR APPROVAL

PRINTING NOTE:

A ISSUE FOR COORDINATION

Rev Description

THIS DRAWING TO BE PRINTED IN COLOUR.

					A
					ے ا
					3
					LE
-					
В	ISSUE FOR APPROVAL	AA	MS	31.03.2023	


AA MS 27.03.2023
Eng Draft Date

SJB ARCHITECTURE
LEVEL 2, 490 CROWN ST, SURRY HILLS, NSW


IRIS CAPITAL LEVEL 41/264 GEORGE ST, SYDNEY NSW 2000



T: 02 8810 5800 E: info@xavierknight.com.au
A: Level 7, 210 Clarence Street, Sydney NSW 2000
xavierknight.com.au
This drawing is copyright and is the property of XAVIER KNIGHT CONSULTING ENGINEERS Pty. Ltd. and must not be used

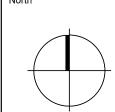

	EAST END STAGE 3 & 4 HUNTER, MORGAN, NEWCOMEN, KING STREET NEWCASTLE NSW 2300	Scale at A1	Drawn MS	Approved SS
_	Sheet Subject	Job No	Drawing No	Revision
	COVER PAGE	220901	C000	В

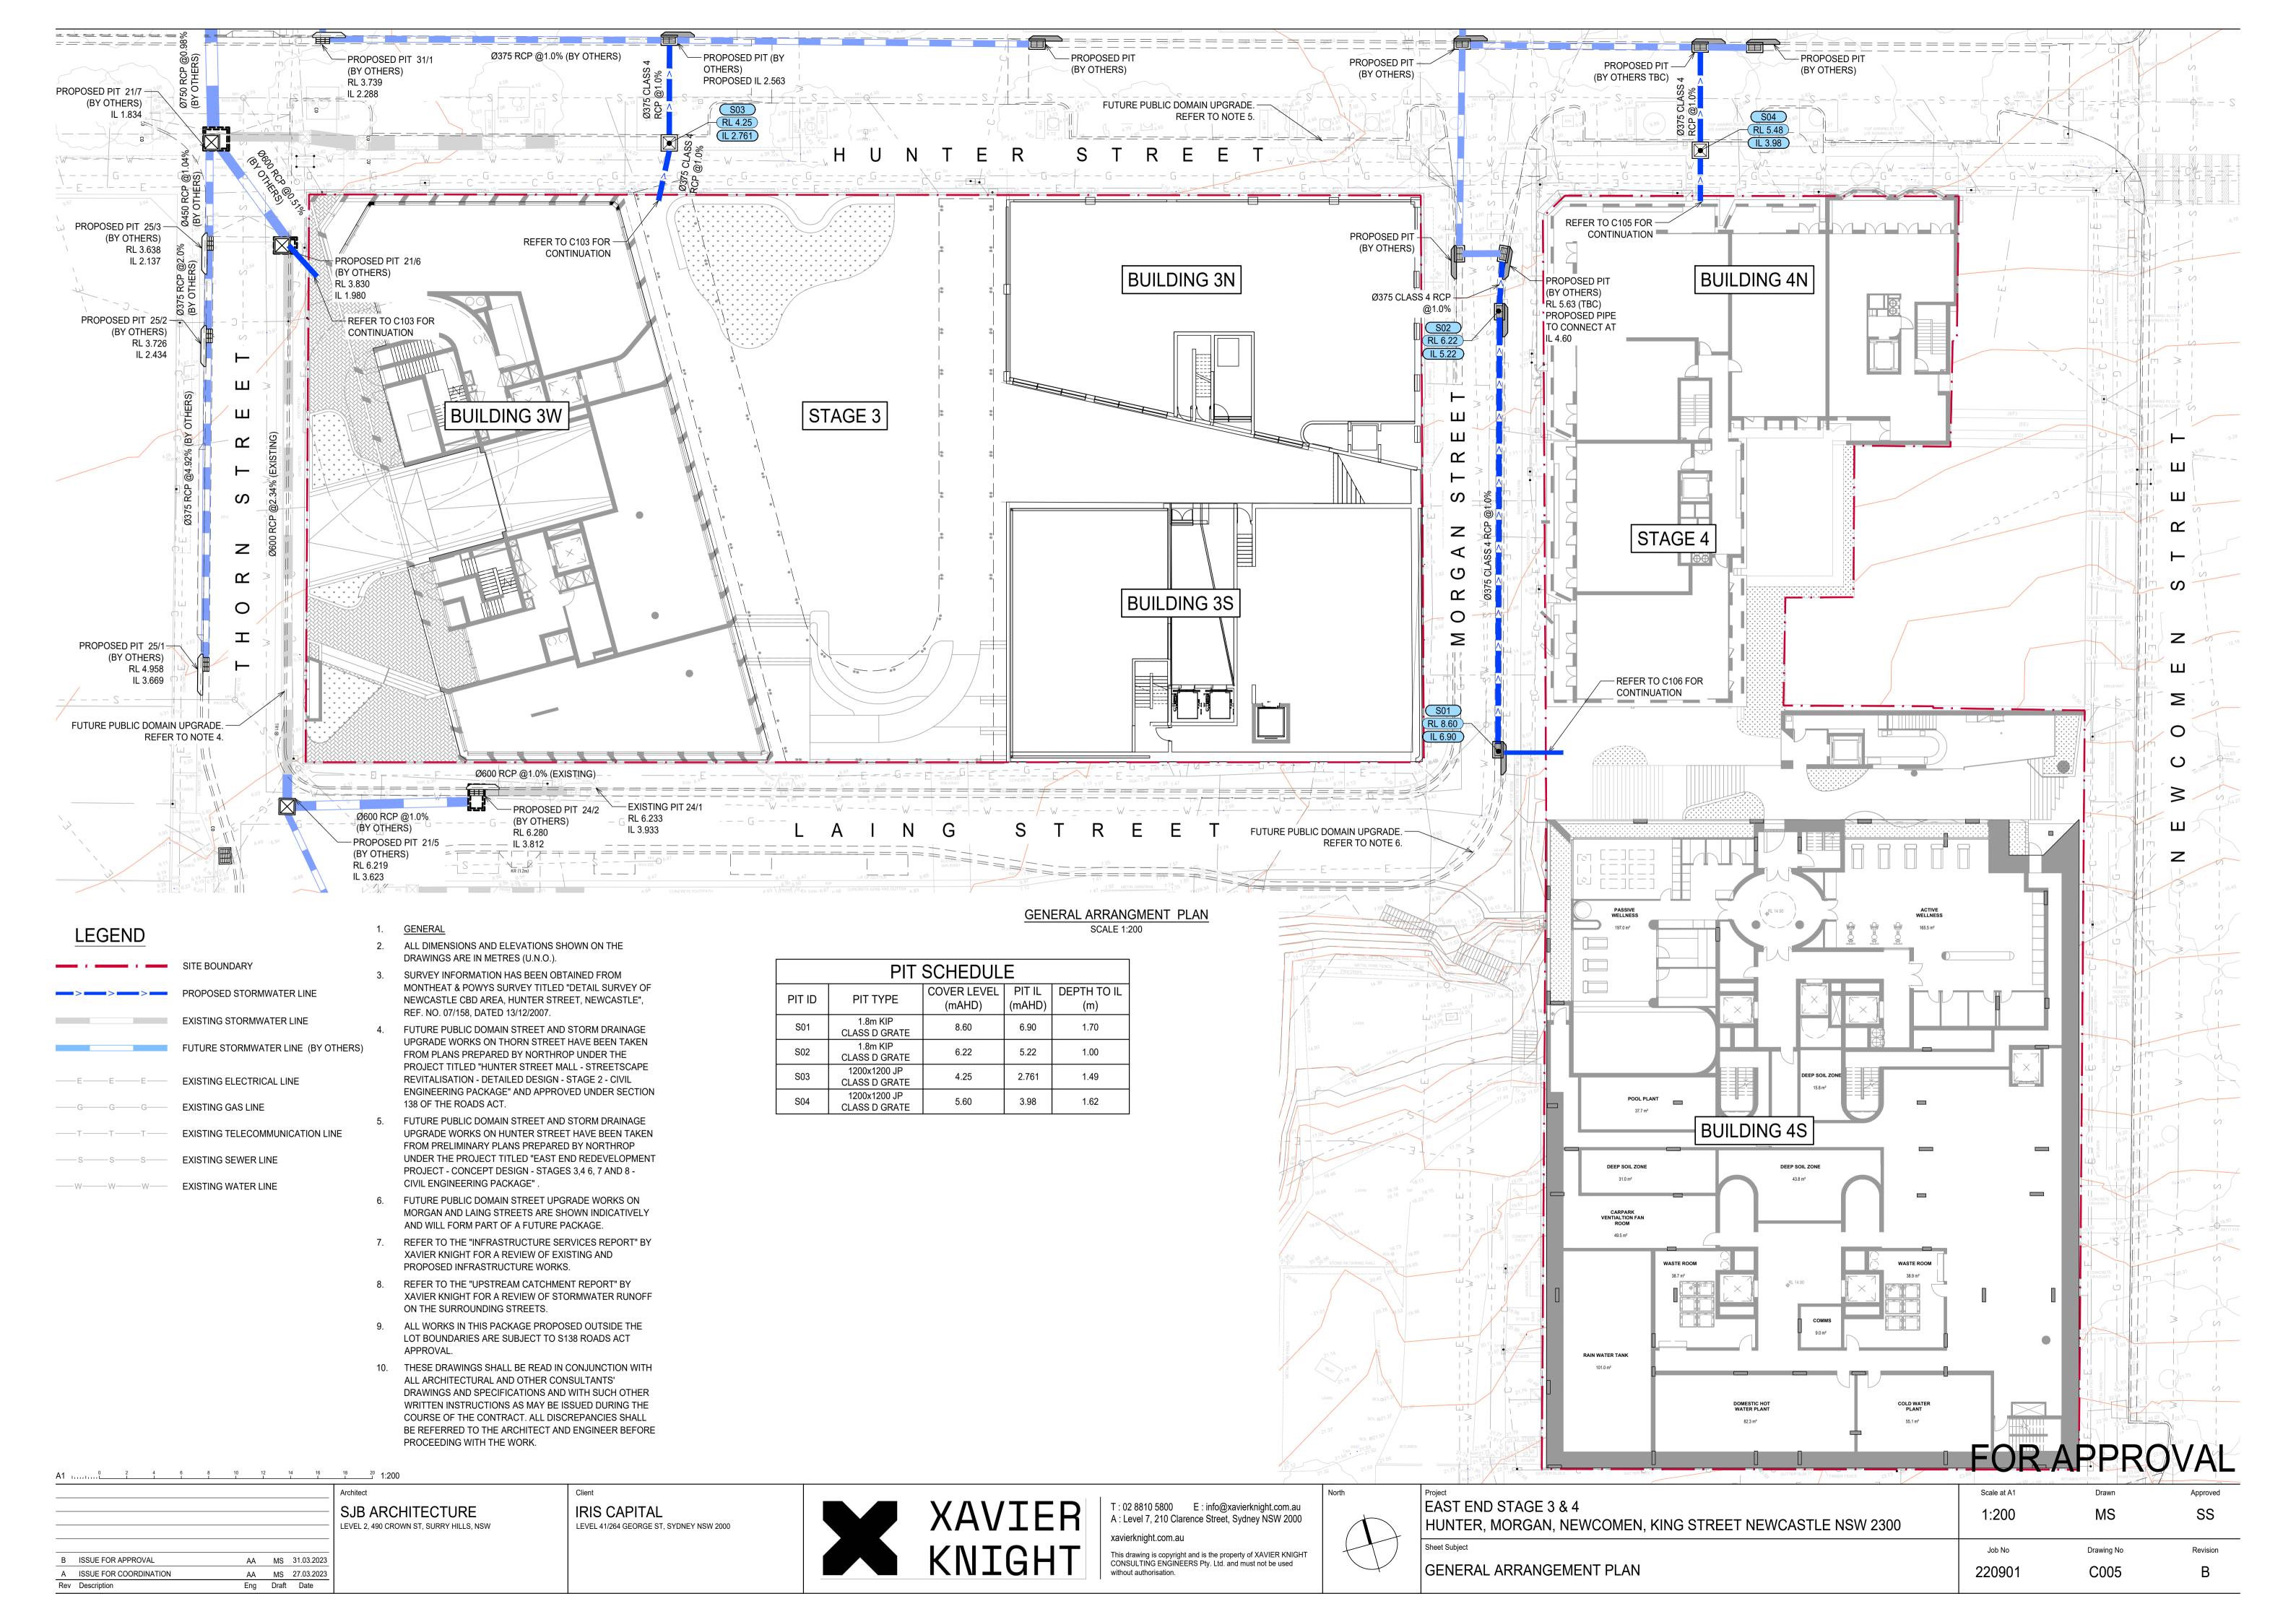

PUMP-OUT PIT CALCS

100yr 2hr ARI STORM = 59.70 mm/hr ARI x 2 = 119.4 mm

TOTAL UNCOVERED AREA DRAINING INTO BASEMENT AND PUMP OUT PIT:

- EXPOSED DRIVEWAY = 47 m² - VERTICAL WALL FACE OVER DRIVEWAY = 198 x 0.5 = 99.0 m² (1H: 2V RAINFALL ANGLE) TOTAL AREA = 146 m²

UNDERGROUND PUMP TANK VOLUME REQUIRED $V = 146 \times 119.40 / 1000 = 17.4 \text{ m}^3$

THEREFORE, 18.0 m³ VOLUME PIT WAS PROVIDED

PUMP SPECIFICATION I_{100} (5 min) = 316 mm/hr

PUMP-OUT RATE BASED ON 100-YR 5 min STORM = C I A / 3600 = 0.9 x 316x 146 / 3600 = 11.53 L/s

PUMP-OUT PIT TO BE INSTALLED WITH

FOLLOWING ITEMS: - 2 x SUBMERSIBLE PUMPS TO BE INSTALLED IN SUMP AND CONNECTED TO CONTROL PANEL WHICH WILL ALLOW FOR THE PUMP TO OPERATE

SIMULTANEOUSLY ON HIGH-LEVEL ALARMS WITH DUTY OF 11.53 L/s AT 8.15 m


900SQ HEAVY DUTY GALVANIZED STEEL GRATE AND FRAME. WARNING FLASHING LIGHT TO PROVIDE

INDICATION OF PUMP FAILURE.

CONFINED SPACE SIGN FOR PUBLIC AWARENESS AND WARNING.

STEP IRONS.

= 692 L/min

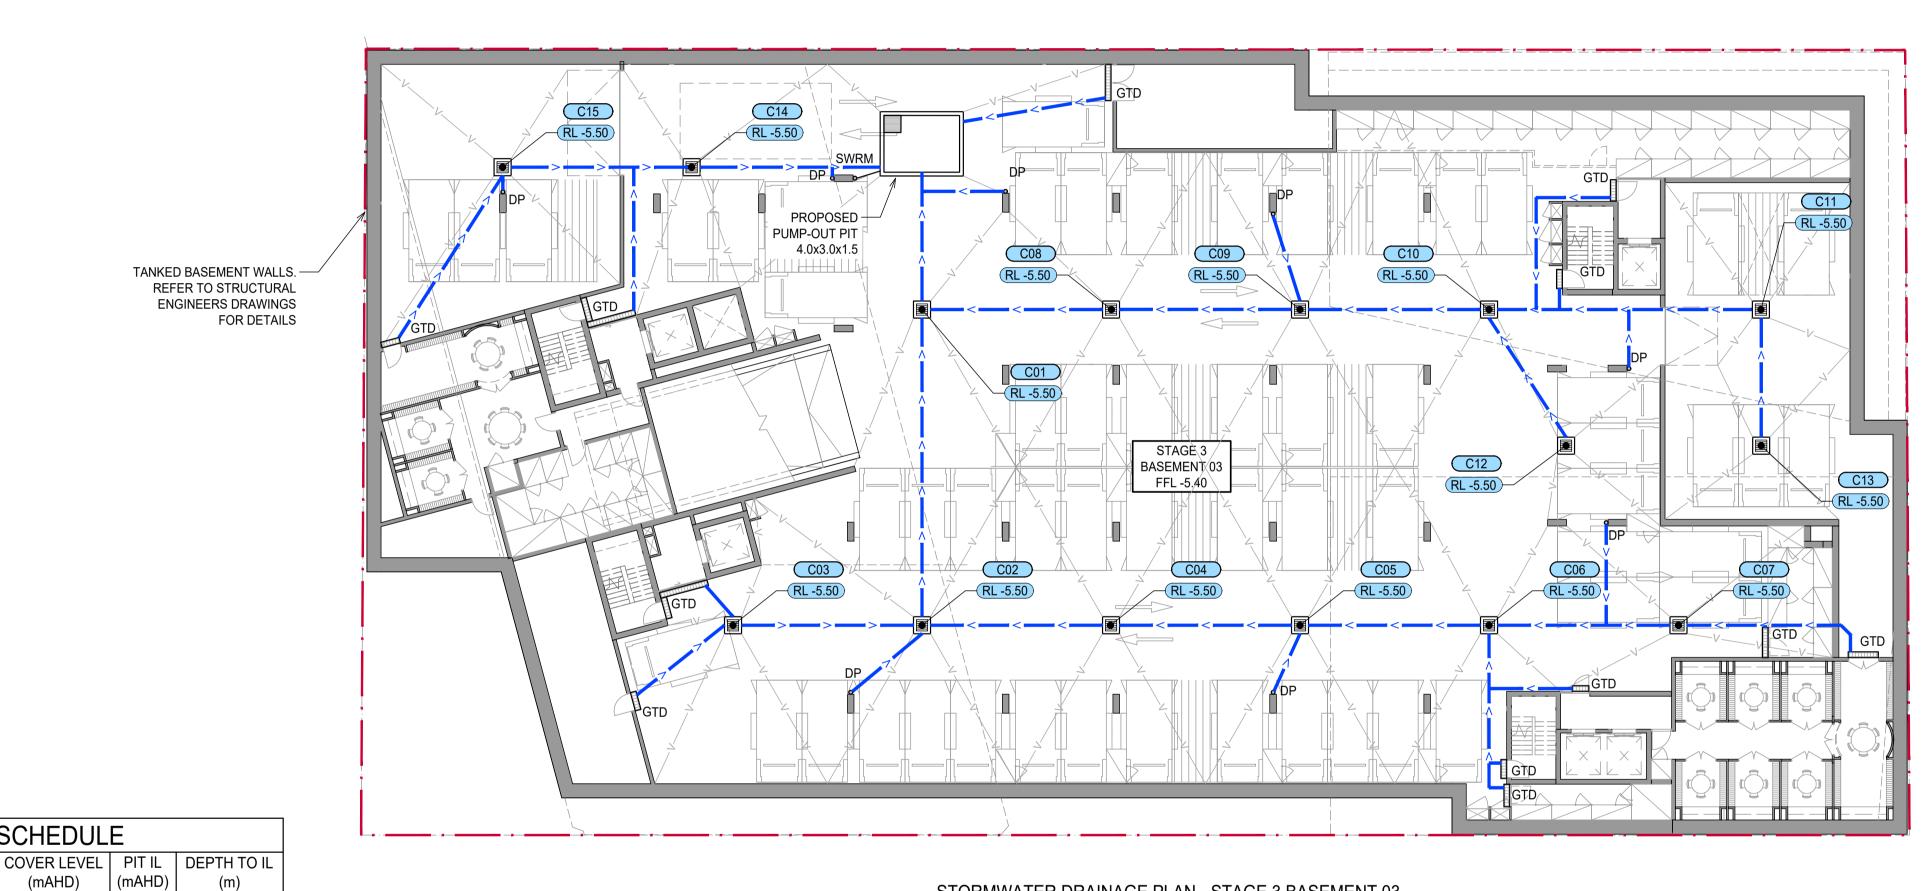

STORMWATER DRAINAGE PLAN - STAGE 3 BASEMENT 03 SCALE 1:200

GENERAL

1. ALL DIMENSIONS ARE IN mm UNLESS NOTED OTHERWISE

LEGEND

DP Ø

VD Ø

PD Ø

FW ₪

(PIT A02)

SWRM

SITE BOUNDARY

—————— OUTLINE OF LEVEL ABOVE

——RM———RISING MAIN

───V───V───V VALLEY LINE

> PROPOSED STORMWATER LINE

PROPOSED GRATED DRAIN

GRATED SURFACE INLET PIT

STORMWATER RISING MAIN

SEALED JUNCTION PIT

DOWN PIPE OUTLET

VERTICAL DROP

PLANTER DRAIN

FLOOR WASTE

PIT TAG/NUMBER

FINISHED RL

- 2. ALL PIPES ARE TO BE MINIMUM Ø100mm uPVC STRAPPED TO UNDERSIDE OF SLAB U.N.O.
- 3. ALL PIPES ARE TO BE AT 1% MINIMUM GRADE U.N.O.
- 4. SLAB TO BE GRADED 1% TOWARDS PITS TO MEET REQUIREMENTS OF AS

PIT SCHEDULE

(mAHD)

-5.50

-5.50

Eng Draft Date

-6.47

-5.90

-6.20

-6.00

-6.30

-6.20

-5.90

-6.01

-5.90

-6.00

-5.90

0.97

0.80

0.40

0.70

0.60

0.50

0.40

0.80

0.70

0.60

0.40

0.51

0.40

0.50

0.40

PIT ID

C01

C02

C03

C04

C05

C06

C08

C09

C11

C12

C13

C14

Rev Description

PIT TYPE

900x900 GSIP

CLASS D GRATE 600x600 GSIP

CLASS D GRATE 600x600 GSIP

CLASS D GRATE 450x450 GSIP

CLASS D GRATE 900x900 GSIP

CLASS D GRATE

600x600 GSIP

CLASS D GRATE

600x600 GSIP

CLASS D GRATE

450x450 GSIP

CLASS D GRATE 450x450 GSIP

CLASS D GRATE 450x450 GSIP

CLASS D GRATE 450x450 GSIP


CLASS D GRATE

AA MS 31.03.2023 AA MS 27.03.2023 A ISSUE FOR COORDINATION


SJB ARCHITECTURE LEVEL 2, 490 CROWN ST, SURRY HILLS, NSW IRIS CAPITAL LEVEL 41/264 GEORGE ST, SYDNEY NSW 2000



T : 02 8810 5800 E : info@xavierknight.com.au A : Level 7, 210 Clarence Street, Sydney NSW 2000 This drawing is copyright and is the property of XAVIER KNIGHT CONSULTING ENGINEERS Pty. Ltd. and must not be used without authorisation.

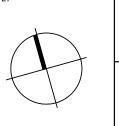

	FOR	APPR(DVAL
EAST END STAGE 3 & 4 HUNTER, MORGAN, NEWCOMEN, KING STREET NEWCASTLE NSW 2300	Scale at A1 1:200	Drawn MS	Approved SS
Sheet Subject STORMWATER MANAGEMENT PLAN STAGE 3 BASEMENT 03	Job No 220901	Drawing No	Revision B

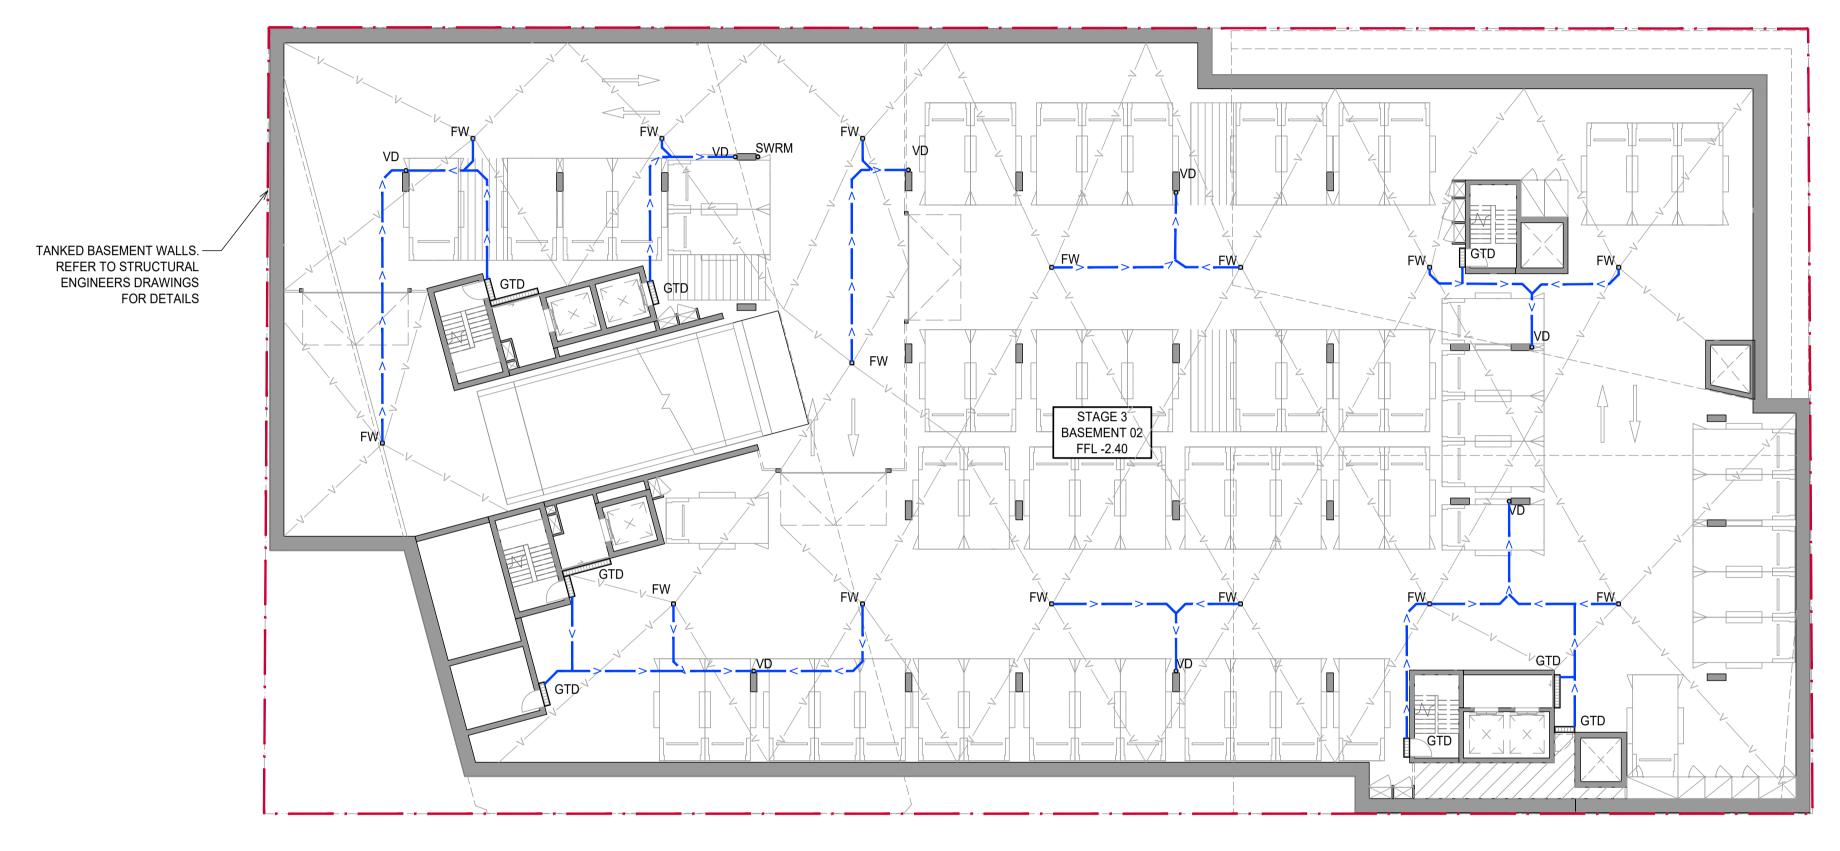

STORMWATER DRAINAGE PLAN - STAGE 3 BASEMENT 02

GENERAL

1. ALL DIMENSIONS ARE IN mm UNLESS NOTED OTHERWISE

LEGEND

DP Ø

VD Ø

PD Ø

SWRM

FW 🛮

SITE BOUNDARY

-----V------VALLEY LINE

—————— OUTLINE OF LEVEL ABOVE

> PROPOSED STORMWATER LINE

PROPOSED GRATED DRAIN

GRATED SURFACE INLET PIT

SEALED JUNCTION PIT

DOWN PIPE OUTLET

VERTICAL DROP

PLANTER DRAIN

FLOOR WASTE

PIT TAG/NUMBER

FINISHED RL

STORMWATER RISING MAIN

- 2. ALL PIPES ARE TO BE MINIMUM Ø100mm uPVC STRAPPED TO UNDERSIDE OF SLAB U.N.O.
- 3. ALL PIPES ARE TO BE AT 1% MINIMUM GRADE U.N.O.
- 4. SLAB TO BE GRADED 1% TOWARDS PITS TO MEET REQUIREMENTS OF AS 2890.

1 2 4 9 9 10 12 13 10 10 12 11 1200

 B
 ISSUE FOR APPROVAL
 AA
 MS
 31.03.2023

 A
 ISSUE FOR COORDINATION
 AA
 MS
 27.03.2023


 Rev
 Description
 Eng
 Draft
 Date

SJB ARCHITECTURE
LEVEL 2, 490 CROWN ST, SURRY HILLS, NSW


IRIS CAPITAL
LEVEL 41/264 GEORGE ST, SYDNEY NSW 2000



T: 02 8810 5800 E: info@xavierknight.com.au
A: Level 7, 210 Clarence Street, Sydney NSW 2000
xavierknight.com.au
This drawing is copyright and is the property of XAVIER KNIGHT CONSULTING ENGINEERS Pty. Ltd. and must not be used without authorisation.

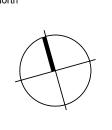

	FOR	APPR(JAVC
EAST END STAGE 3 & 4 HUNTER, MORGAN, NEWCOMEN, KING STREET NEWCASTLE NSW 2300	Scale at A1 1:200	Drawn MS	Approved SS
Sheet Subject STORMWATER MANAGEMENT PLAN STAGE 3 BASEMENT 02	Job No 220901	Drawing No C101	Revision B

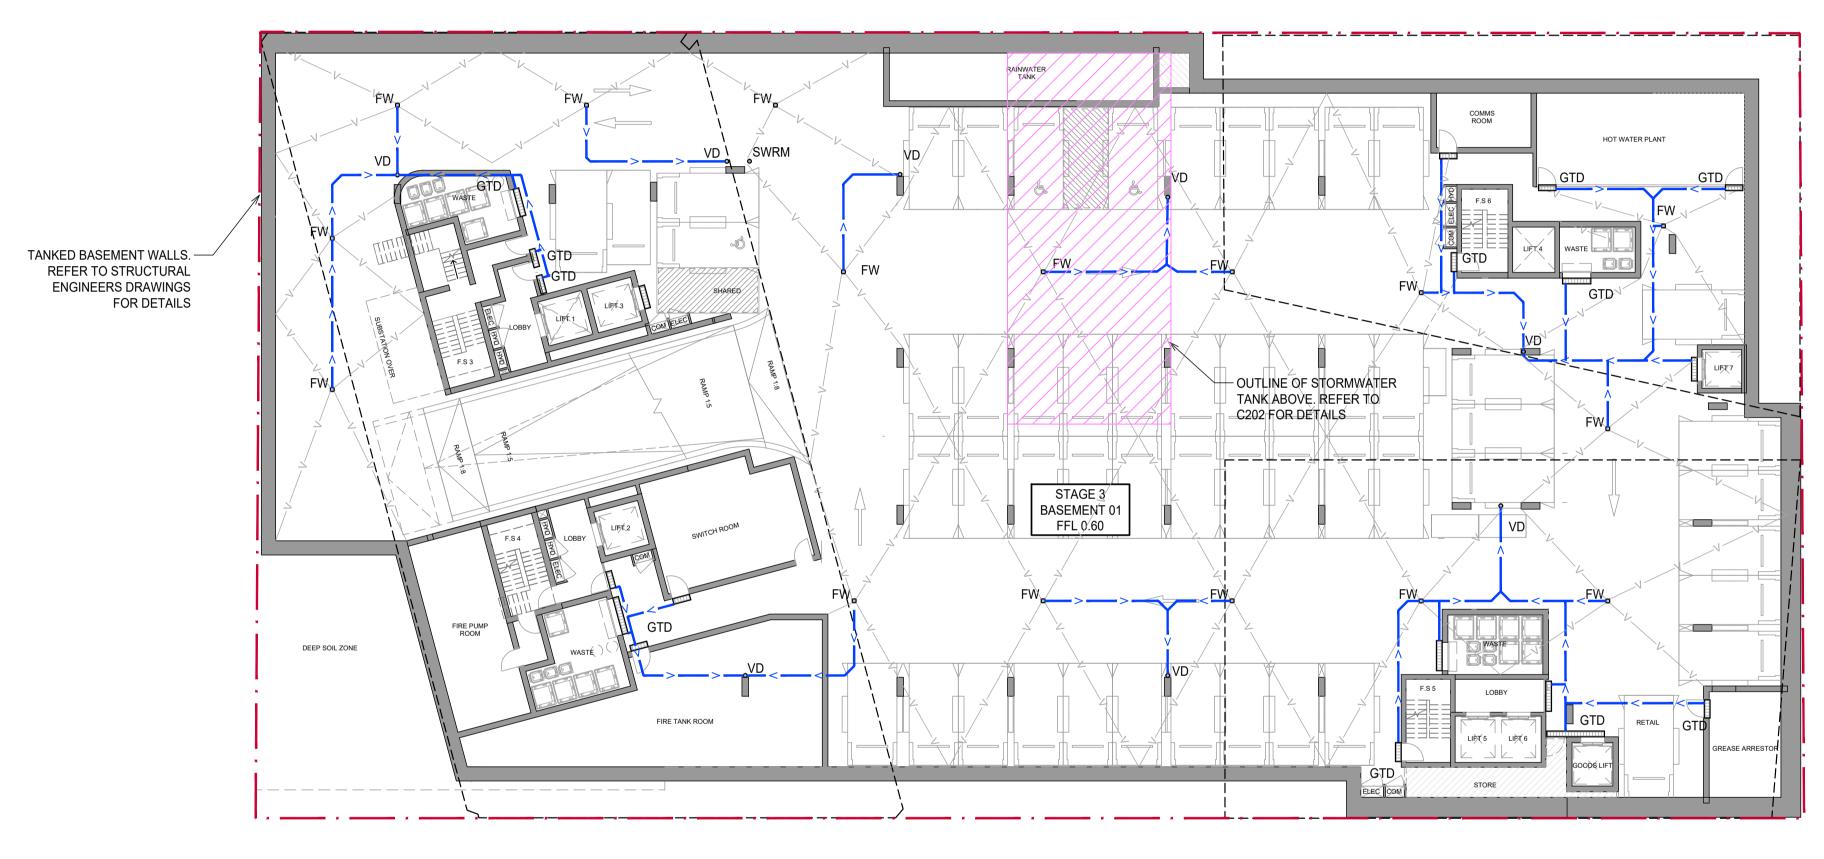

STORMWATER DRAINAGE PLAN - STAGE 3 BASEMENT 01
SCALE 1:200

GENERAL

1. ALL DIMENSIONS ARE IN mm UNLESS NOTED OTHERWISE

LEGEND

DP Ø

VD Ø

PD Ø

SWRM

SITE BOUNDARY

-----V------VALLEY LINE

—————— OUTLINE OF LEVEL ABOVE

> PROPOSED STORMWATER LINE

PROPOSED GRATED DRAIN

GRATED SURFACE INLET PIT

SEALED JUNCTION PIT

DOWN PIPE OUTLET

VERTICAL DROP

PLANTER DRAIN

FLOOR WASTE

PIT TAG/NUMBER

FINISHED RL

STORMWATER RISING MAIN

- 2. ALL PIPES ARE TO BE MINIMUM Ø100mm uPVC STRAPPED TO UNDERSIDE OF SLAB U.N.O.
- 3. ALL PIPES ARE TO BE AT 1% MINIMUM GRADE U.N.O.
- 4. SLAB TO BE GRADED 1% TOWARDS PITS TO MEET REQUIREMENTS OF AS 2890.

Architect

 B
 ISSUE FOR APPROVAL
 AA
 MS
 31.03.2023

 A
 ISSUE FOR COORDINATION
 AA
 MS
 27.03.2023

 Rev
 Description
 Eng
 Draft
 Date

SJB ARCHITECTURE


LEVEL 2, 490 CROWN ST, SURRY HILLS, NSW

IRIS CAPITAL


LEVEL 41/264 GEORGE ST, SYDNEY NSW 2000




T: 02 8810 5800 E: info@xavierknight.com.au
A: Level 7, 210 Clarence Street, Sydney NSW 2000
xavierknight.com.au
This drawing is copyright and is the property of XAVIER KNIGHT CONSULTING ENGINEERS Pty. Ltd. and must not be used without authorisation.

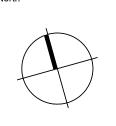

	FOR	APPR(DVAL
EAST END STAGE 3 & 4 HUNTER, MORGAN, NEWCOMEN, KING STREET NEWCASTLE NSW 2300	Scale at A1 1:200	Drawn MS	Approved SS
Sheet Subject STORMWATER MANAGEMENT PLAN STAGE 3 BASEMENT 01	Job No 220901	Drawing No C102	Revision B

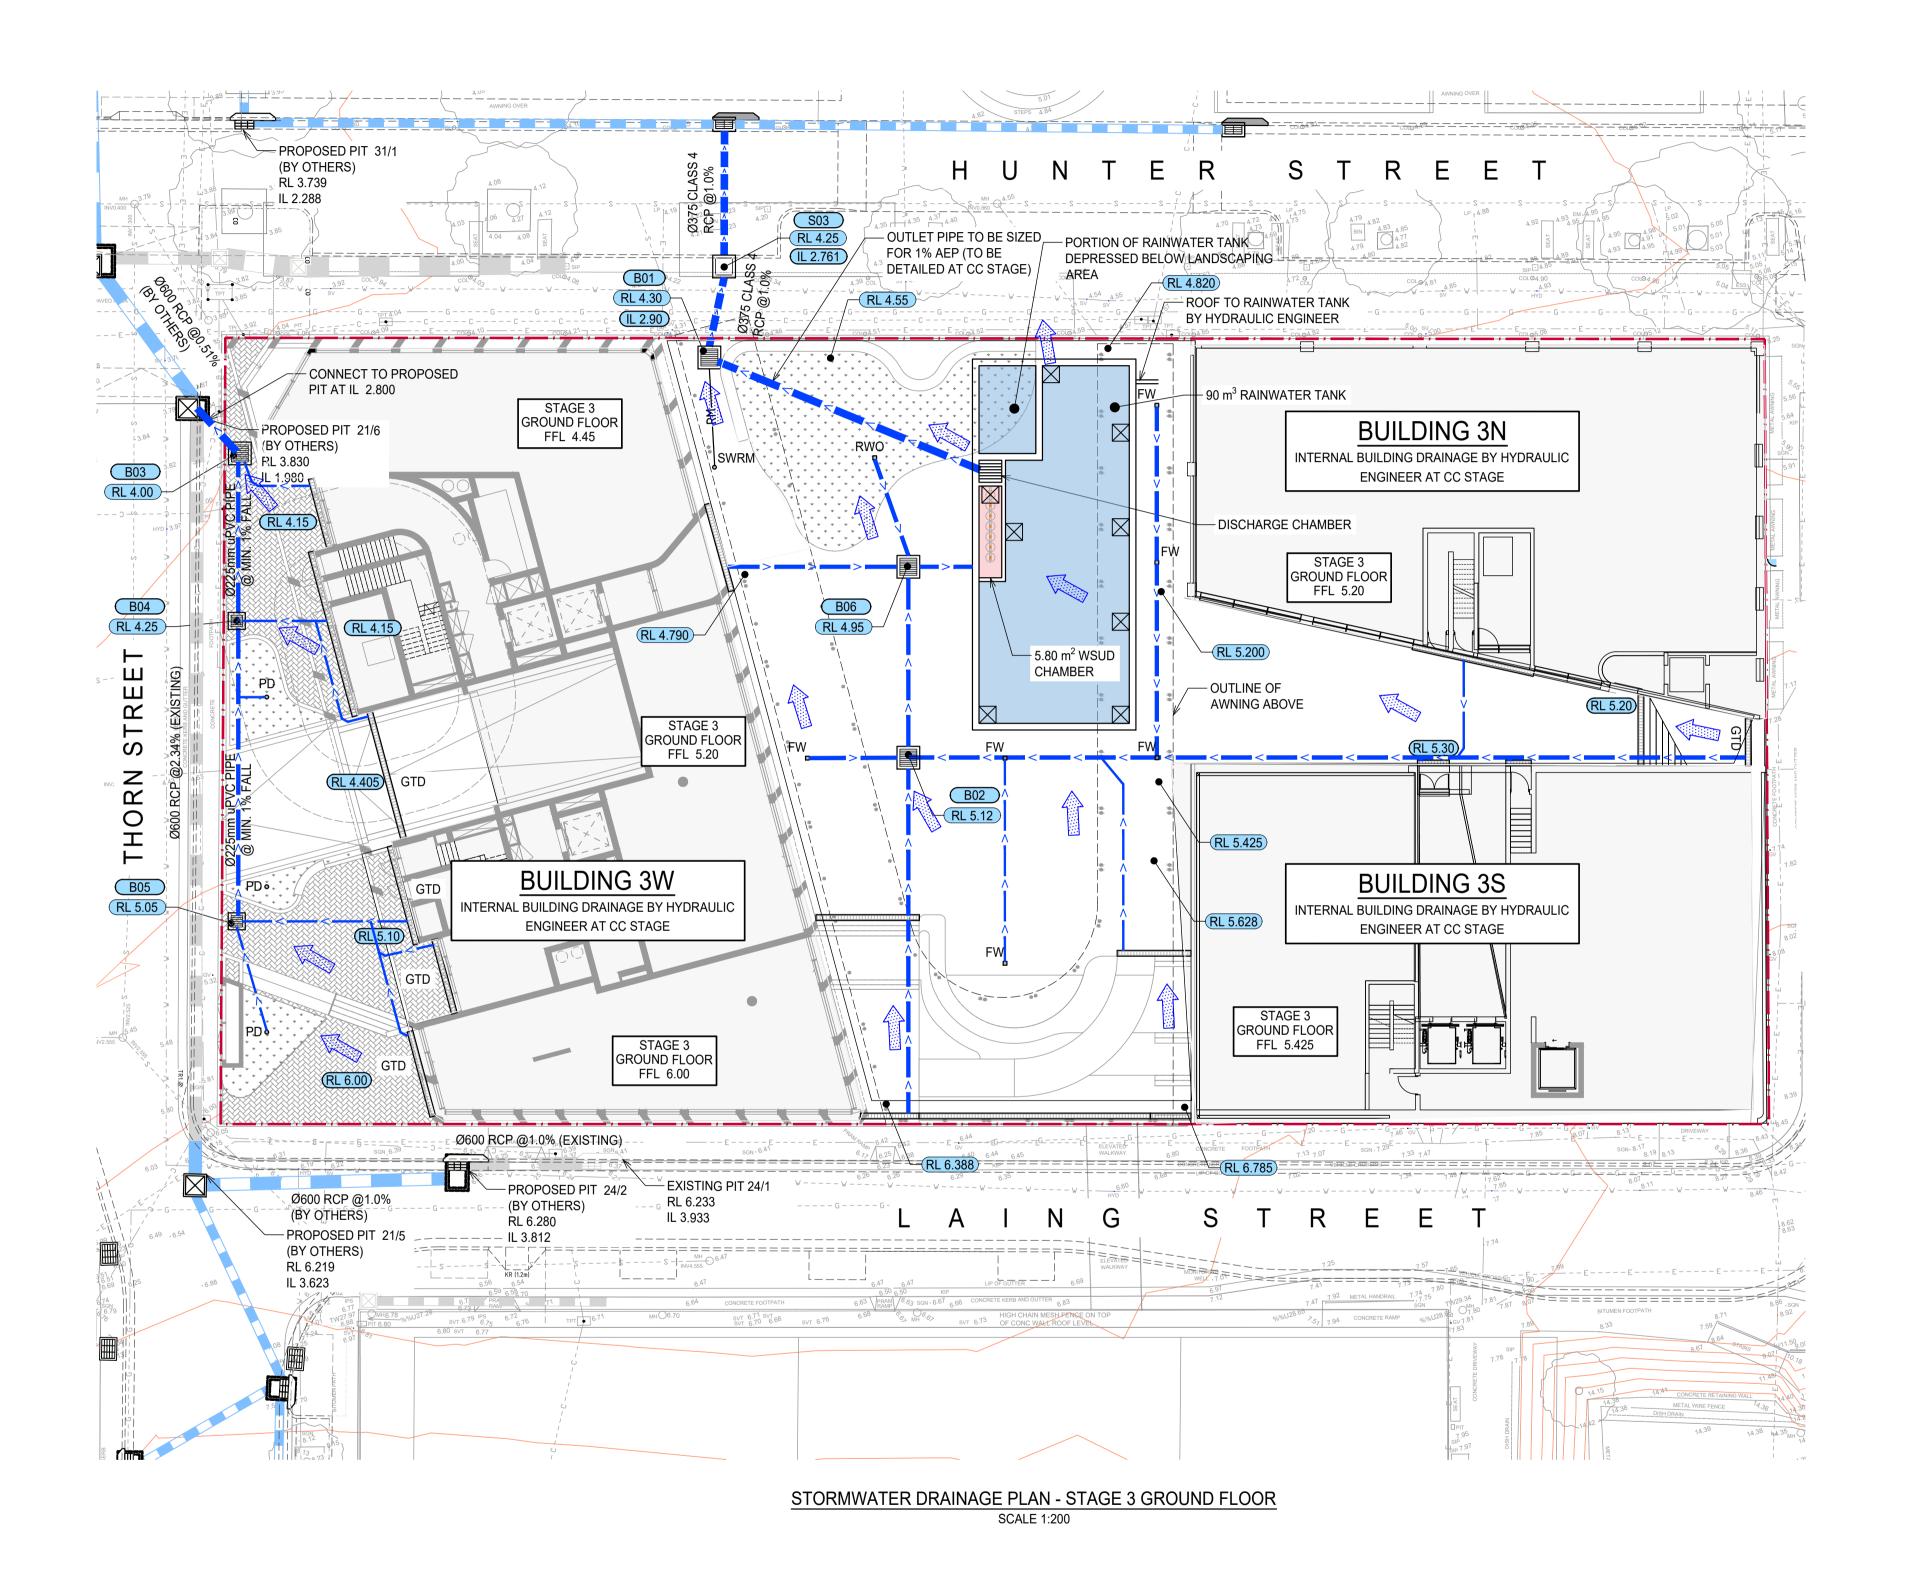

LEGEND

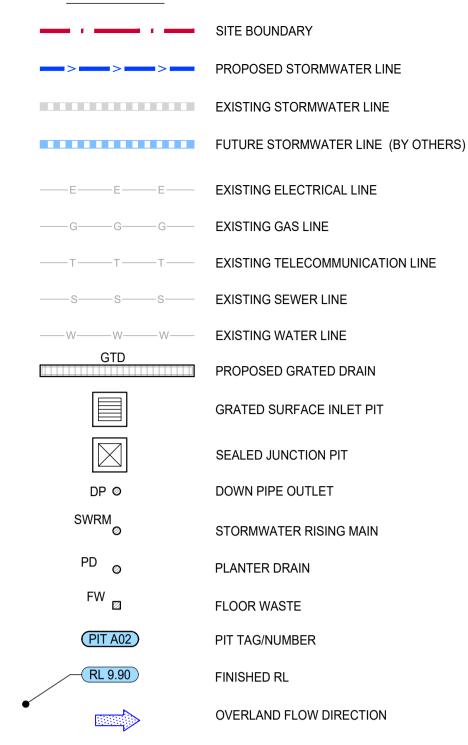



PIT SCHEDULE						
PIT ID	PIT TYPE	COVER LEVEL (mAHD)	PIT IL (mAHD)	DEPTH TO IL (m)	NOTES	
B01	1200x1200 GSIP CLASS B GRATE	4.30	2.90	1.40	FITTED WITH OCEANGUARD	
B02	900x900 GSIP CLASS B GRATE	5.12	4.05	1.07	FITTED WITH OCEANGUARD	
B03	900x900 GSIP CLASS B GRATE	4.00	3.03	0.97	FITTED WITH OCEANGUARD	
B04	600x600 GSIP CLASS B GRATE	4.25	3.65	0.60	FITTED WITH OCEANGUARD	
B05	600x600 GSIP CLASS B GRATE	5.10	4.50	0.60	FITTED WITH OCEANGUARD	
B06	600x600 GSIP CLASS B GRATE	4.95	3.95	1.00	FITTED WITH OCEANGUARD	

- 1. GENERAL
- 2. ALL DIMENSIONS AND ELEVATIONS SHOWN ON THE DRAWINGS ARE IN METRES (U.N.O.).
- 3. SURVEY INFORMATION HAS BEEN OBTAINED FROM MONTHEAT & POWYS SURVEY TITLED "DETAIL SURVEY OF NEWCASTLE CBD AREA, HUNTER STREET, NEWCASTLE", REF. NO. 07/158, DATED 13/12/2007.
- 4. FUTURE PUBLIC DOMAIN STREET AND STORM DRAINAGE UPGRADE WORKS ON THORN STREET HAVE BEEN TAKEN FROM PLANS PREPARED BY NORTHROP UNDER THE PROJECT TITLED "HUNTER STREET MALL STREETSCAPE REVITALISATION DETAILED DESIGN STAGE 2 CIVIL ENGINEERING PACKAGE" AND APPROVED UNDER SECTION 138 OF THE ROADS ACT.
- 5. FUTURE PUBLIC DOMAIN STREET AND STORM DRAINAGE UPGRADE WORKS ON HUNTER STREET HAVE BEEN TAKEN FROM PRELIMENARY PLANS PREPARED BY NORTHROP UNDER THE PROJECT TITLED "EAST END REDEVELOPMENT PROJECT CONCEPT DESIGN STAGES 3,4 6, 7 AND 8 CIVIL ENGINEERING PACKAGE".
- 6. FUTURE PUBLIC DOMAIN STREET UPGRADE WORKS ON MORGAN AND LAING STREETS ARE SHOWN INDICATIVELY AND WILL FORM PART OF A FUTURE PACKAGE.
- 7. ALL WORKS IN THIS PACKAGE PROPOSED OUTSIDE THE LOT BOUNDARIES ARE SUBJECT TO \$138 ROADS ACT APPROVAL.
- 8. THESE DRAWINGS SHALL BE READ IN CONJUNCTION WITH ALL ARCHITECTURAL AND OTHER CONSULTANTS' DRAWINGS AND SPECIFICATIONS AND WITH SUCH OTHER WRITTEN INSTRUCTIONS AS MAY BE ISSUED DURING THE COURSE OF THE CONTRACT. ALL DISCREPANCIES SHALL BE REFERRED TO THE ARCHITECT AND ENGINEER BEFORE PROCEEDING WITH THE WORK.

FOR APPROVAL

Scale at A1 XAVIER EAST END STAGE 3 & 4 T : 02 8810 5800 E : info@xavierknight.com.au A : Level 7, 210 Clarence Street, Sydney NSW 2000 IRIS CAPITAL SJB ARCHITECTURE MS 1:200 HUNTER, MORGAN, NEWCOMEN, KING STREET NEWCASTLE NSW 2300 LEVEL 2, 490 CROWN ST, SURRY HILLS, NSW LEVEL 41/264 GEORGE ST, SYDNEY NSW 2000 xavierknight.com.au Drawing No Job No This drawing is copyright and is the property of XAVIER KNIGHT CONSULTING ENGINEERS Pty. Ltd. and must not be used STORMWATER MANAGEMENT PLAN B ISSUE FOR APPROVAL NV MS 31.03.2023 C103 220901 A ISSUE FOR COORDINATION NV MS 27.03.2023 STAGE 3 GROUNDFLOOR PLAN Rev Description Eng Draft Date

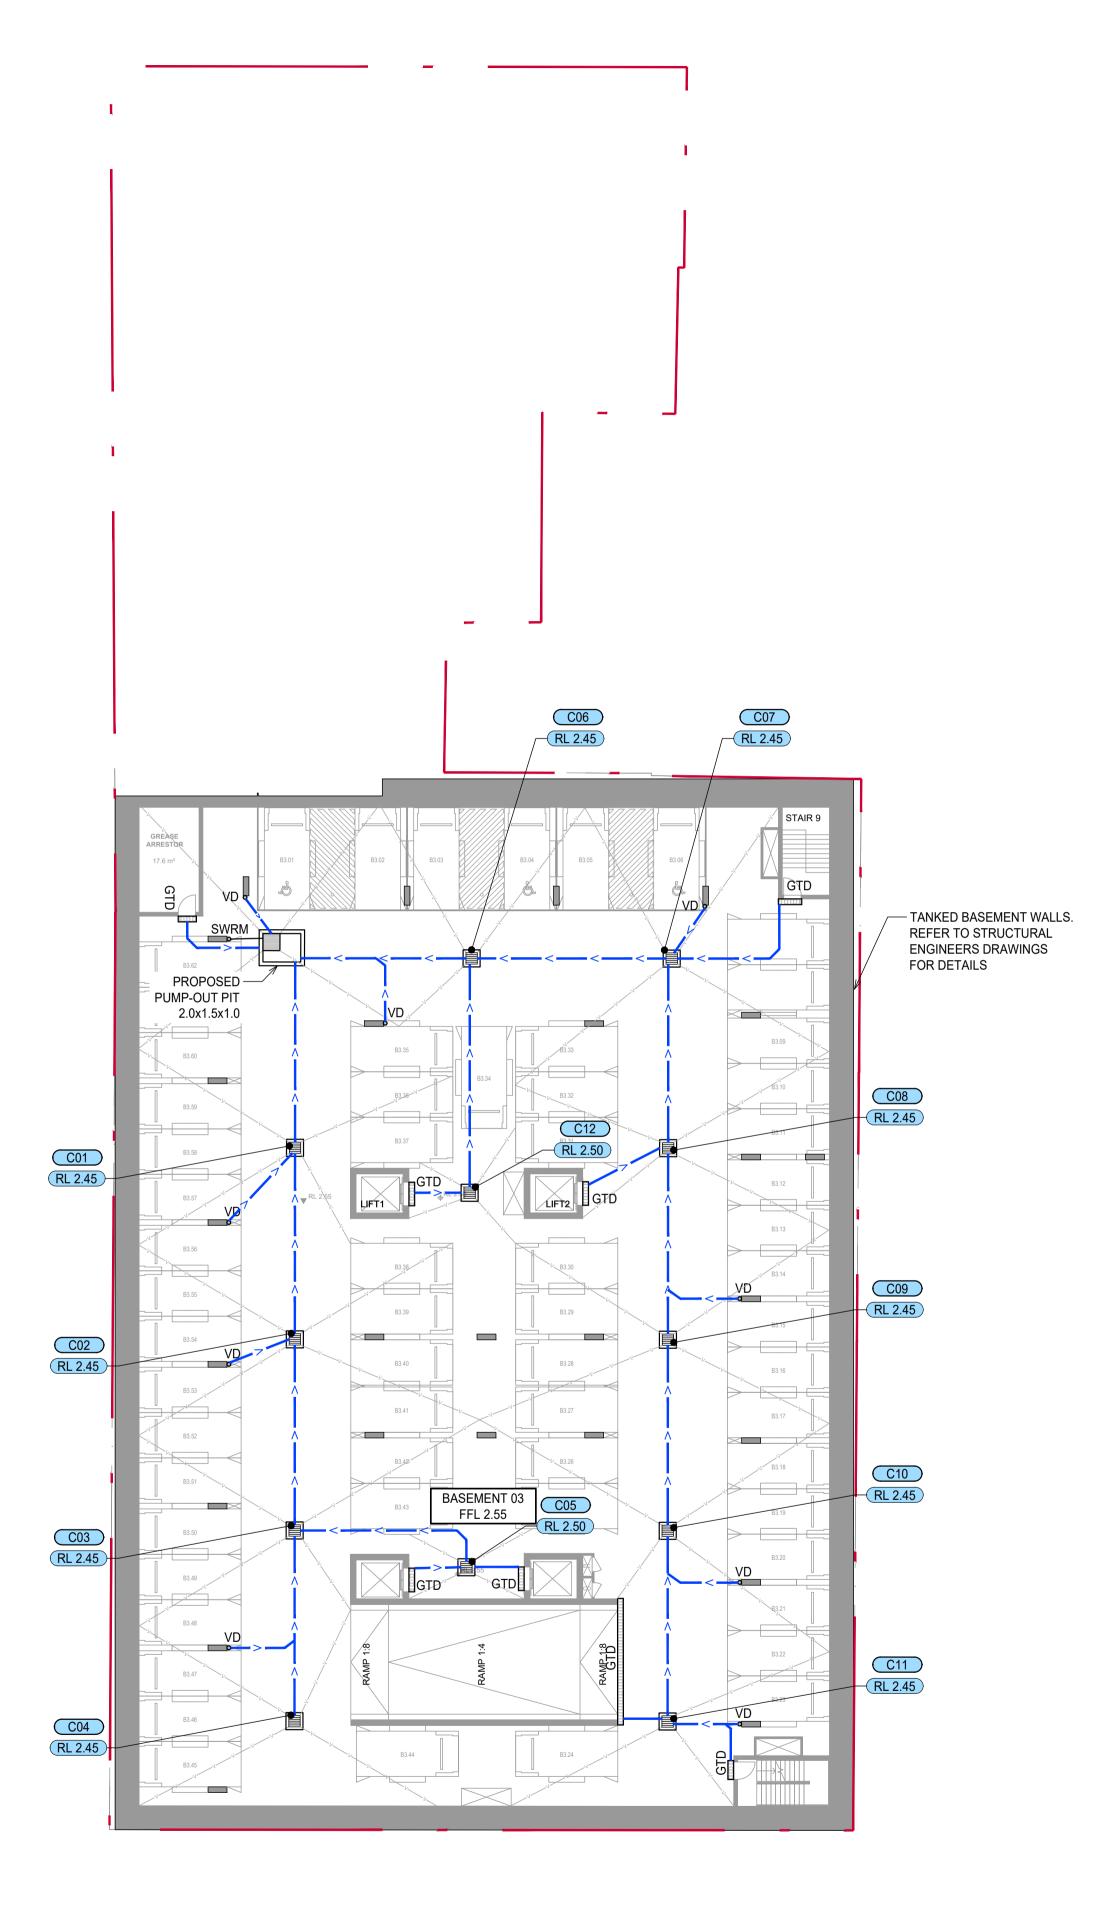

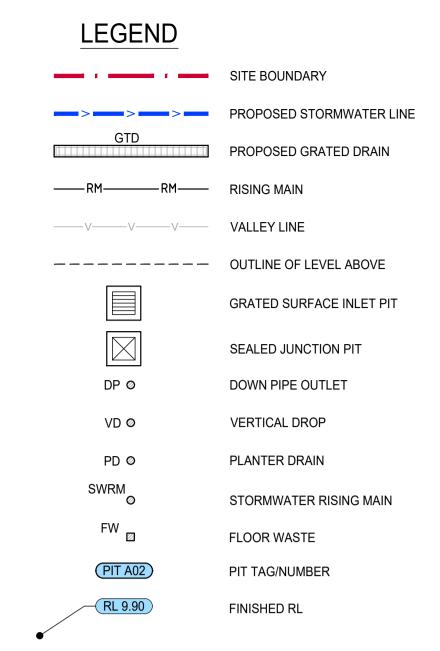

PUMP-OUT PIT NOTE

PROVIDE 3m³ PUMP-OUT PIT TO MEET THE MINIMUM REQUIREMENTS.

PUMP-OUT PIT TO BE INSTALLED WITH

- FOLLOWING ITEMS:
- 2 x SUBMERSIBLE PUMPS WITH DUTY OF 5 L/s AT 8.15 m HEAD.
- 900SQ HEAVY DUTY GALVANIZED STEEL
- GRATE AND FRAME.
 WARNING FLASHING LIGHT TO PROVIDE
- INDICATION OF PUMP FAILURE.
 CONFINED SPACE SIGN FOR PUBLIC
- AWARENESS AND WARNING.
 STEP IRONS.

	PIT SCHEDULE					
PIT ID	PIT TYPE	COVER LEVEL	PIT IL	DEPTH TO IL		
FILID	FILTIFE	(mAHD)	(mAHD)	(m)		
C01	900x900 GSIP CLASS D GRATE	2.45	1.75	0.70		
C02	600x600 GSIP CLASS D GRATE	2.45	1.85	0.60		
C03	600x600 GSIP CLASS D GRATE	2.45	1.95	0.50		
C04	450x450 GSIP CLASS D GRATE	2.45	2.05	0.40		
C05	450x450 GSIP CLASS D GRATE	2.50	2.05	0.45		
C06	450x450 GSIP CLASS D GRATE	2.45	1.55	0.90		
C07	450x450 GSIP CLASS D GRATE	2.50	1.65	0.85		
C08	450x450 GSIP CLASS D GRATE	2.50	1.75	0.75		
C09	900x900 GSIP CLASS D GRATE	2.45	1.85	0.60		
C10	600x600 GSIP CLASS D GRATE	2.45	1.95	0.50		
C11	600x600 GSIP CLASS D GRATE	2.45	2.05	0.40		
C12	450x450 GSIP CLASS D GRATE	2.50	2.05	0.45		

GENERAL

- 1. ALL DIMENSIONS ARE IN mm UNLESS NOTED OTHERWISE
- 2. ALL PIPES ARE TO BE MINIMUM Ø100mm uPVC STRAPPED TO UNDERSIDE OF SLAB U.N.O.
- 3. ALL PIPES ARE TO BE AT 1% MINIMUM GRADE U.N.O.
- 4. SLAB TO BE GRADED 1% TOWARDS PITS TO MEET REQUIREMENTS OF AS 2890.

STORMWATER DRAINAGE PLAN - STAGE 4S BASEMENT 03

Architect

SJB ARCHITECTURE

LEVEL 2, 490 CROWN ST, SURRY HILLS, NSW

Client

IRIS CAPITAL

LEVEL 41/264 GEORGE ST, SYDNEY NSW 2000

NV MS 31.03.2023

NV MS 27.03.2023 Eng Draft Date


B ISSUE FOR APPROVAL

Rev Description


A ISSUE FOR COORDINATION



T: 02 8810 5800 E: info@xavierknight.com.au
A: Level 7, 210 Clarence Street, Sydney NSW 2000
xavierknight.com.au
This drawing is copyright and is the property of XAVIER KNIGHT CONSULTING ENGINEERS Pty. Ltd. and must not be used without authorisation.

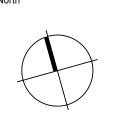

	FOR	APPR(JAVC
EAST END STAGE 3 & 4 HUNTER, MORGAN, NEWCOMEN, KING STREET NEWCASTLE NSW 2300	Scale at A1 1:200	Drawn MS	Approved SS
Sheet Subject STORMWATER MANAGEMENT PLAN STAGE 4S BASEMENT 03	Job No 220901	Drawing No C104	Revision

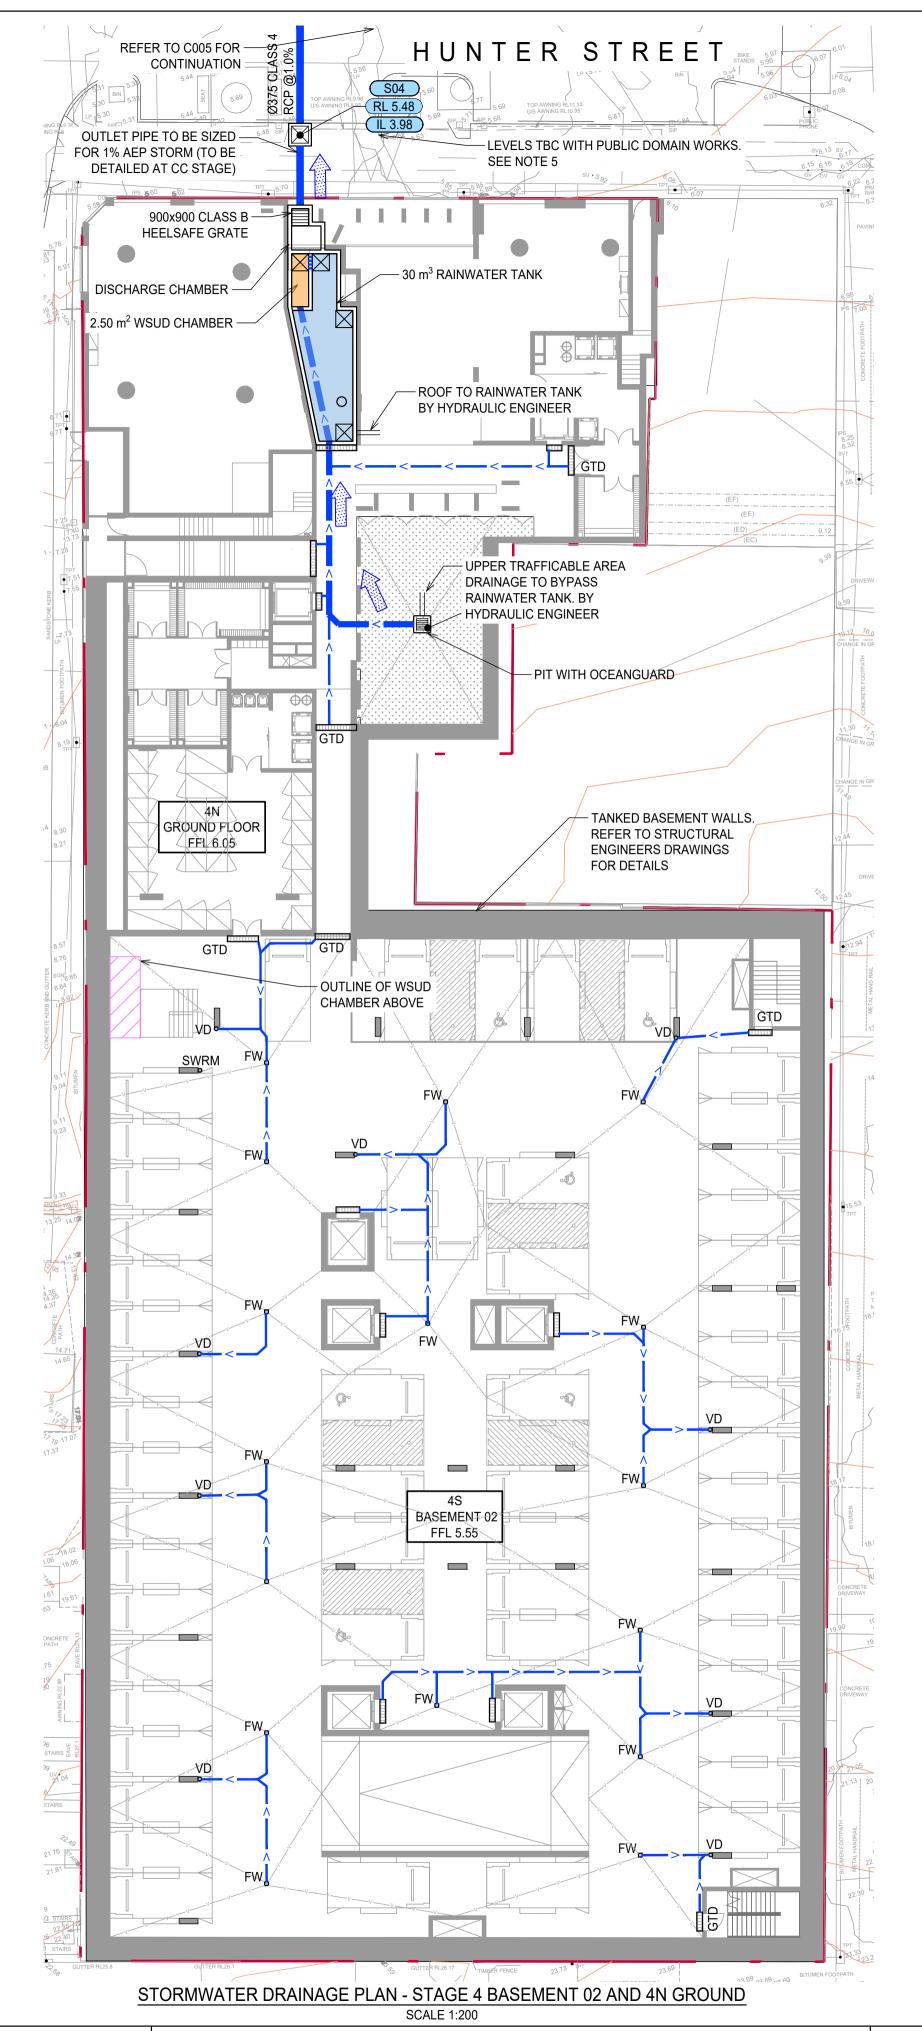

PIT SCHEDULE COVER LEVEL | PIT IL | DEPTH TO IL PIT TYPE PIT ID (mAHD) (mAHD) FITTED WITH 900x900 GSIP OCEANGUARD C01 6.00 5.08 0.92 CLASS B GRATE AND HEELSAFE GRATE

LEGEND SITE BOUNDARY > PROPOSED STORMWATER LINE PROPOSED GRATED DRAIN ——RM———RISING MAIN VALLEY LINE ---- OUTLINE OF LEVEL ABOVE GRATED SURFACE INLET PIT SEALED JUNCTION PIT DP Ø DOWN PIPE OUTLET VD Ø VERTICAL DROP PD Ø PLANTER DRAIN SWRM STORMWATER RISING MAIN FW ₪ FLOOR WASTE (PIT A02) PIT TAG/NUMBER FINISHED RL OVERLAND FLOW DIRECTION

- . <u>GENERAL</u>
- 2. ALL DIMENSIONS AND ELEVATIONS SHOWN ON THE DRAWINGS ARE IN METRES (U.N.O.).
- 3. SURVEY INFORMATION HAS BEEN OBTAINED FROM MONTHEAT & POWYS SURVEY TITLED "DETAIL SURVEY OF NEWCASTLE CBD AREA, HUNTER STREET, NEWCASTLE", REF. NO. 07/158, DATED 13/12/2007.
- 4. FUTURE PUBLIC DOMAIN STREET AND STORM DRAINAGE UPGRADE WORKS ON THORN STREET HAVE BEEN TAKEN FROM PLANS PREPARED BY NORTHROP UNDER THE PROJECT TITLED "HUNTER STREET MALL STREETSCAPE REVITALISATION DETAILED DESIGN STAGE 2 CIVIL ENGINEERING PACKAGE" AND APPROVED UNDER SECTION 138 OF THE ROADS ACT.
- 5. FUTURE PUBLIC DOMAIN STREET AND STORM DRAINAGE UPGRADE WORKS ON HUNTER STREET HAVE BEEN TAKEN FROM PRELIMENARY PLANS PREPARED BY NORTHROP UNDER THE PROJECT TITLED "EAST END REDEVELOPMENT PROJECT CONCEPT DESIGN STAGES 3,4 6, 7 AND 8 CIVIL ENGINEERING PACKAGE".
- 6. FUTURE PUBLIC DOMAIN STREET UPGRADE WORKS ON MORGAN AND LAING STREETS ARE SHOWN INDICATIVELY AND WILL FORM PART OF A FUTURE PACKAGE.
- 7. ALL WORKS IN THIS PACKAGE PROPOSED OUTSIDE THE LOT BOUNDARIES ARE SUBJECT TO S138 ROADS ACT APPROVAL.
- 8. THESE DRAWINGS SHALL BE READ IN CONJUNCTION WITH ALL ARCHITECTURAL AND OTHER CONSULTANTS' DRAWINGS AND SPECIFICATIONS AND WITH SUCH OTHER WRITTEN INSTRUCTIONS AS MAY BE ISSUED DURING THE COURSE OF THE CONTRACT. ALL DISCREPANCIES SHALL BE REFERRED TO THE ARCHITECT AND ENGINEER BEFORE PROCEEDING WITH THE WORK.
- 9. ALL PIPES ARE TO BE MINIMUM Ø100mm uPVC STRAPPED TO UNDERSIDE OF SLAB U.N.O.
- 10. ALL PIPES ARE TO BE AT 1% MINIMUM GRADE U.N.O.
- 11. SLAB TO BE GRADED 1% TOWARDS PITS TO MEET REQUIREMENTS OF AS 2890

FOR COORDINATION

 B
 ISSUE FOR APPROVAL
 NV
 MS
 31.03.2023

 A
 ISSUE FOR COORDINATION
 NV
 MS
 27.03.2023

 Rev
 Description
 Eng
 Draft
 Date

Architect

SJB ARCHITECTURE


LEVEL 2, 490 CROWN ST, SURRY HILLS, NSW

IRIS CAPITAL


LEVEL 41/264 GEORGE ST, SYDNEY NSW 2000



T: 02 8810 5800 E: info@xavierknight.com.au
A: Level 7, 210 Clarence Street, Sydney NSW 2000
xavierknight.com.au
This drawing is copyright and is the property of XAVIER KNIGHT CONSULTING ENGINEERS Pty. Ltd. and must not be used

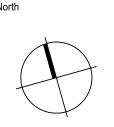

. • .			• . •
Project	Scale at A1	Drawn	Approved
EAST END STAGE 3 & 4 HUNTER, MORGAN, NEWCOMEN, KING STREET NEWCASTLE NSW 2300	1:200	MS	SS
Sheet Subject STORMWATER MANAGEMENT PLAN STAGE 4S BASEMENT 02 AND 4N GROUND	Job No 220901	Drawing No C105	Revision B

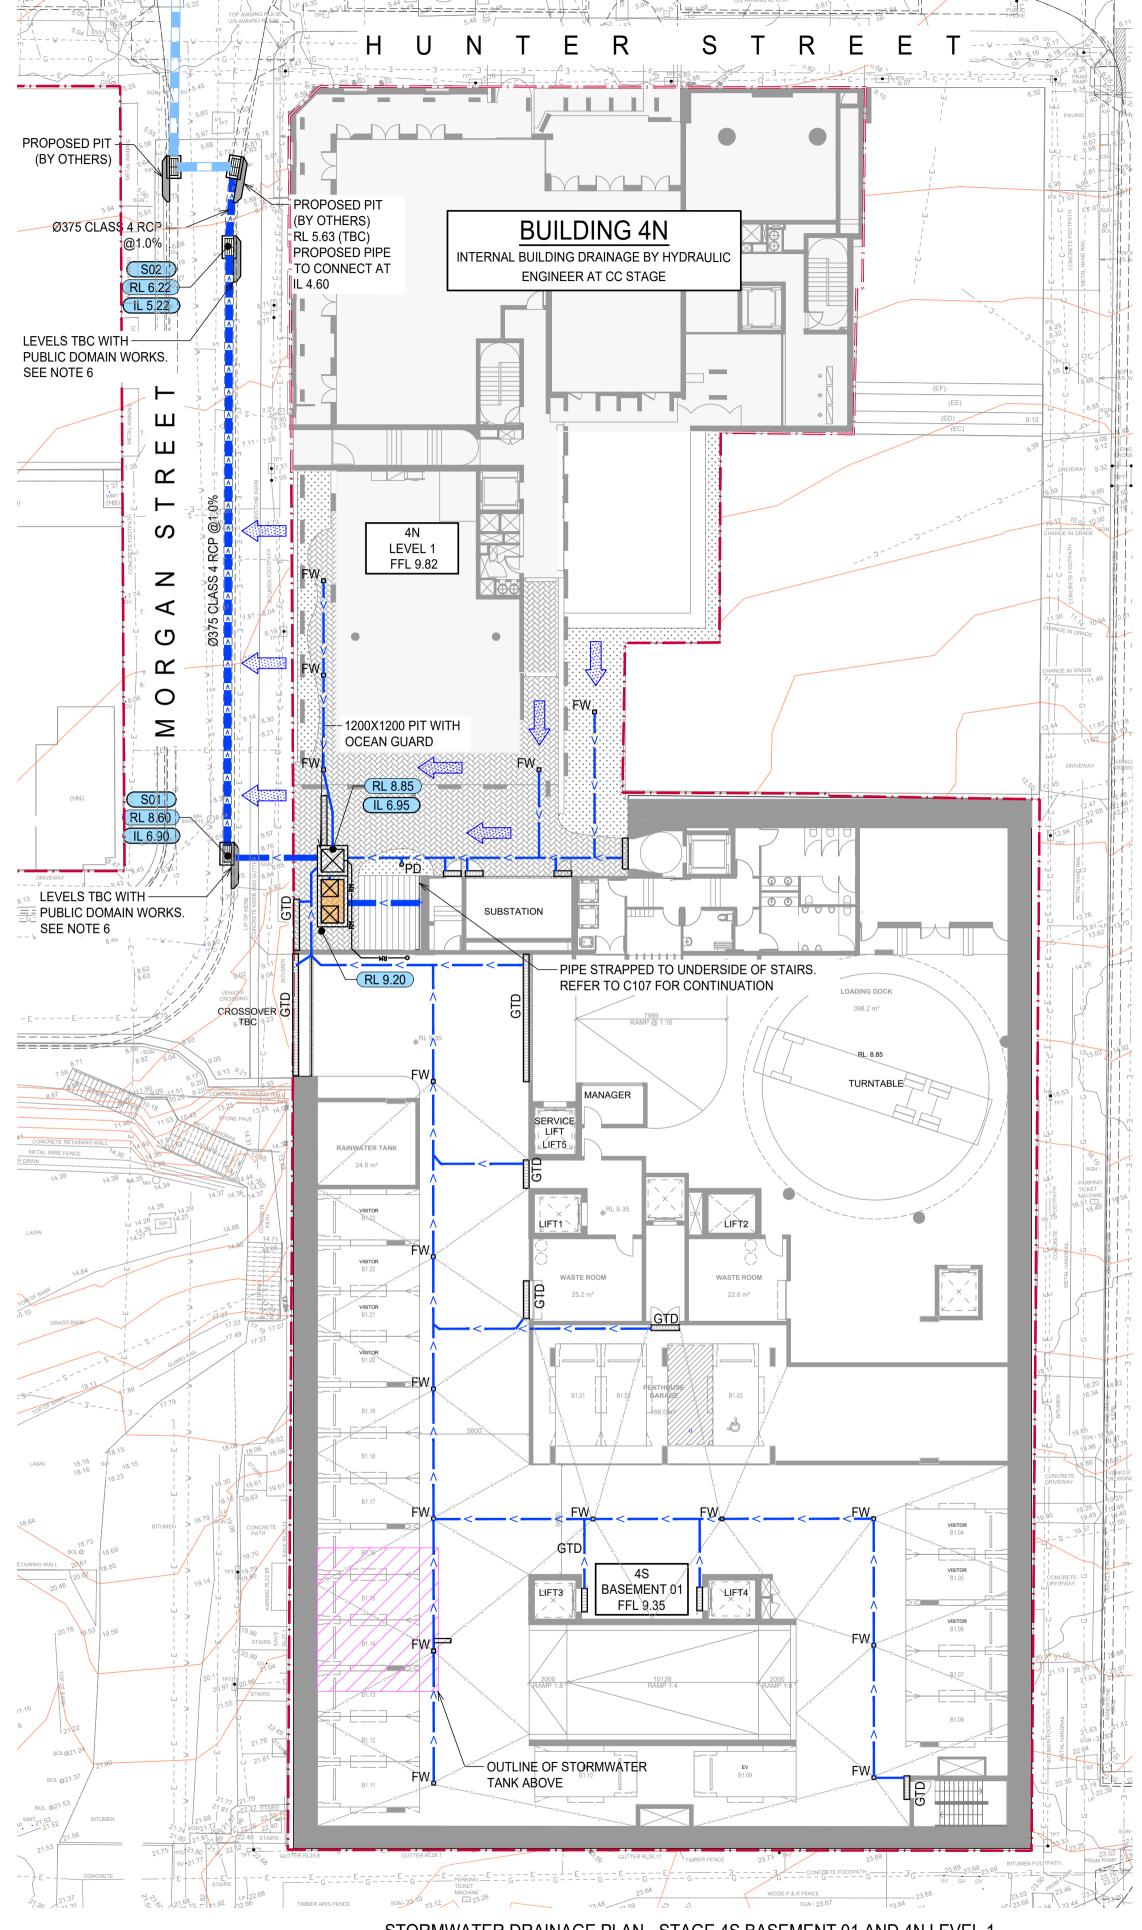

STORMWATER DRAINAGE PLAN - STAGE 4S BASEMENT 01 AND 4N LEVEL 1 SCALE 1:200

B ISSUE FOR APPROVAL
A ISSUE FOR COORDINATION
NV MS 27.03.2023
Rev Description

Architect


SJB ARCHITECTURE

LEVEL 2, 490 CROWN ST, SURRY HILLS, NSW

IRIS CAPITAL
LEVEL 41/264 GEORGE ST, SYDNEY NSW 2000



T: 02 8810 5800 E: info@xavierknight.com.au
A: Level 7, 210 Clarence Street, Sydney NSW 2000
xavierknight.com.au
This drawing is copyright and is the property of XAVIER KNIGHT CONSULTING ENGINEERS Pty. Ltd. and must not be used

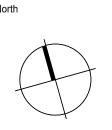

FOR	R COOI	RDINA	TION
EAST END STAGE 3 & 4 HUNTER, MORGAN, NEWCOMEN, KING STREET NEWCASTLE NSW 2300	Scale at A1 1:200	Drawn MS	Approved SS
Sheet Subject STORMWATER MANAGEMENT PLAN STAGE 4S BASEMENT 01 AND 4N LEVEL 1	Job No 220901	Drawing No C106	Revision


SITE BOUNDARY PROPOSED STORMWATER LINE PROPOSED GRATED DRAIN RISING MAIN VALLEY LINE OUTLINE OF LEVEL ABOVE GRATED SURFACE INLET PIT SEALED JUNCTION PIT DP Ø DOWN PIPE OUTLET VERTICAL DROP VD Ø PD Ø PLANTER DRAIN SWRM STORMWATER RISING MAIN FW ₪ FLOOR WASTE PIT A02 PIT TAG/NUMBER

FINISHED RL

OVERLAND FLOW DIRECTION

LEGEND

- . <u>GENERAL</u>
- 2. ALL DIMENSIONS AND ELEVATIONS SHOWN ON THE DRAWINGS ARE IN METRES (U.N.O.).
- 3. SURVEY INFORMATION HAS BEEN OBTAINED FROM MONTHEAT & POWYS SURVEY TITLED "DETAIL SURVEY OF NEWCASTLE CBD AREA, HUNTER STREET, NEWCASTLE", REF. NO. 07/158, DATED 13/12/2007.
- 4. FUTURE PUBLIC DOMAIN STREET AND STORM DRAINAGE UPGRADE WORKS ON THORN STREET HAVE BEEN TAKEN FROM PLANS PREPARED BY NORTHROP UNDER THE PROJECT TITLED "HUNTER STREET MALL STREETSCAPE REVITALISATION DETAILED DESIGN STAGE 2 CIVIL ENGINEERING PACKAGE" AND APPROVED UNDER SECTION 138 OF THE ROADS ACT.
- 5. FUTURE PUBLIC DOMAIN STREET AND STORM DRAINAGE UPGRADE WORKS ON HUNTER STREET HAVE BEEN TAKEN FROM PRELIMENARY PLANS PREPARED BY NORTHROP UNDER THE PROJECT TITLED "EAST END REDEVELOPMENT PROJECT CONCEPT DESIGN STAGES 3,4 6, 7 AND 8 CIVIL ENGINEERING PACKAGE".
- 6. FUTURE PUBLIC DOMAIN STREET UPGRADE WORKS ON MORGAN AND LAING STREETS ARE SHOWN INDICATIVELY AND WILL FORM PART OF A FUTURE PACKAGE.
- 7. ALL WORKS IN THIS PACKAGE PROPOSED OUTSIDE THE LOT BOUNDARIES ARE SUBJECT TO S138 ROADS ACT APPROVAL.
- 8. THESE DRAWINGS SHALL BE READ IN CONJUNCTION WITH ALL ARCHITECTURAL AND OTHER CONSULTANTS' DRAWINGS AND SPECIFICATIONS AND WITH SUCH OTHER WRITTEN INSTRUCTIONS AS MAY BE ISSUED DURING THE COURSE OF THE CONTRACT. ALL DISCREPANCIES SHALL BE REFERRED TO THE ARCHITECT AND ENGINEER BEFORE PROCEEDING WITH THE WORK.
- 9. ALL PIPES ARE TO BE MINIMUM Ø100mm uPVC STRAPPED TO UNDERSIDE OF SLAB U.N.O.
- 10. ALL PIPES ARE TO BE AT 1% MINIMUM GRADE U.N.O.
- 11. SLAB TO BE GRADED 1% TOWARDS PITS TO MEET REQUIREMENTS OF AS 2890.

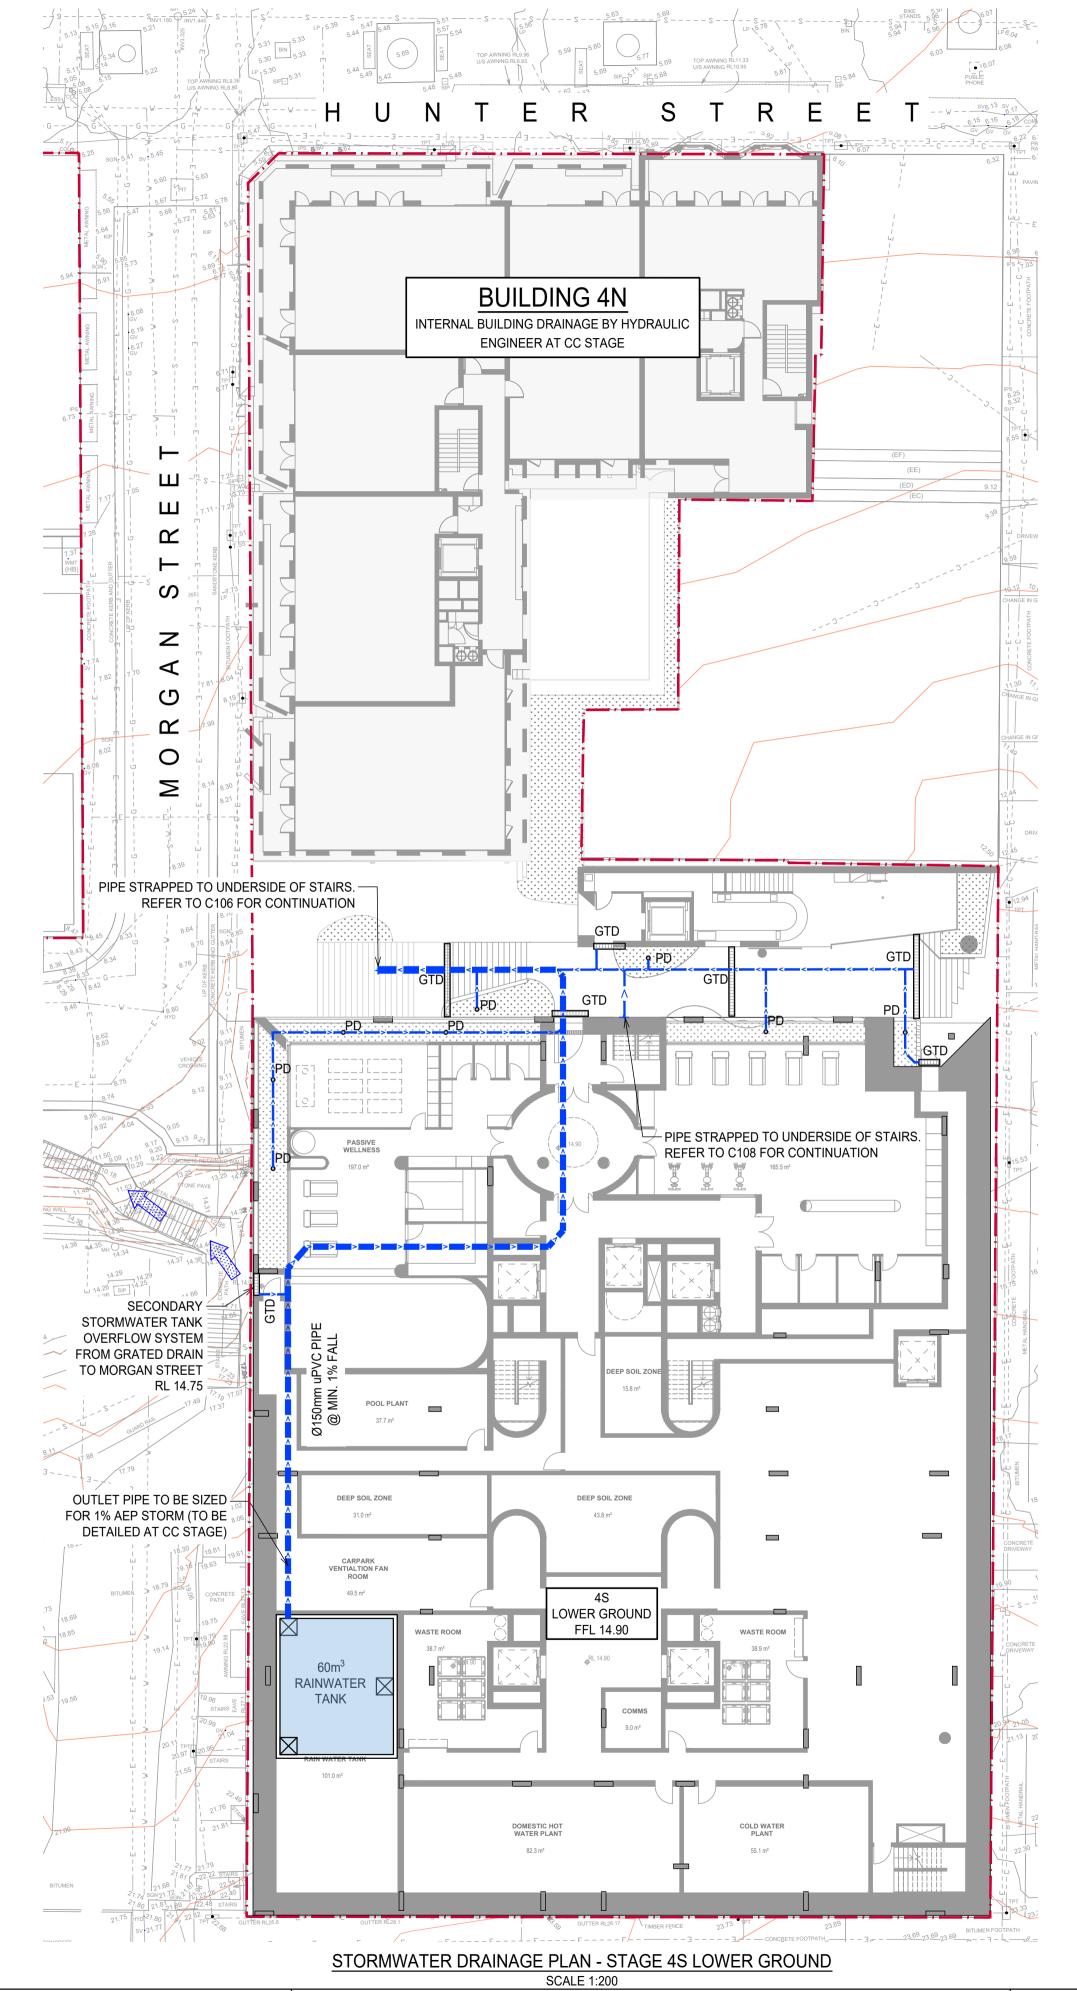

LEGEND SITE BOUNDARY > PROPOSED STORMWATER LINE PROPOSED GRATED DRAIN RISING MAIN VALLEY LINE OUTLINE OF LEVEL ABOVE GRATED SURFACE INLET PIT SEALED JUNCTION PIT DP Ø DOWN PIPE OUTLET VD Ø VERTICAL DROP PD Ø PLANTER DRAIN SWRM STORMWATER RISING MAIN FW ₪ FLOOR WASTE PIT A02 PIT TAG/NUMBER

FINISHED RL

- 1. <u>GENERAL</u>
- 2. ALL DIMENSIONS AND ELEVATIONS SHOWN ON THE DRAWINGS ARE IN METRES (U.N.O.).
- 3. SURVEY INFORMATION HAS BEEN OBTAINED FROM MONTHEAT & POWYS SURVEY TITLED "DETAIL SURVEY OF NEWCASTLE CBD AREA, HUNTER STREET, NEWCASTLE", REF. NO. 07/158, DATED 13/12/2007.
- 4. FUTURE PUBLIC DOMAIN STREET AND STORM DRAINAGE UPGRADE WORKS ON THORN STREET HAVE BEEN TAKEN FROM PLANS PREPARED BY NORTHROP UNDER THE PROJECT TITLED "HUNTER STREET MALL STREETSCAPE REVITALISATION DETAILED DESIGN STAGE 2 CIVIL ENGINEERING PACKAGE" AND APPROVED UNDER SECTION 138 OF THE ROADS ACT.
- 5. FUTURE PUBLIC DOMAIN STREET AND STORM DRAINAGE UPGRADE WORKS ON HUNTER STREET HAVE BEEN TAKEN FROM PRELIMENARY PLANS PREPARED BY NORTHROP UNDER THE PROJECT TITLED "EAST END REDEVELOPMENT PROJECT CONCEPT DESIGN STAGES 3,4 6, 7 AND 8 CIVIL ENGINEERING PACKAGE".
- 6. FUTURE PUBLIC DOMAIN STREET UPGRADE WORKS ON MORGAN AND LAING STREETS ARE SHOWN INDICATIVELY AND WILL FORM PART OF A FUTURE PACKAGE.
- 7. ALL WORKS IN THIS PACKAGE PROPOSED OUTSIDE THE LOT BOUNDARIES ARE SUBJECT TO S138 ROADS ACT APPROVAL.
- 8. THESE DRAWINGS SHALL BE READ IN CONJUNCTION WITH ALL ARCHITECTURAL AND OTHER CONSULTANTS' DRAWINGS AND SPECIFICATIONS AND WITH SUCH OTHER WRITTEN INSTRUCTIONS AS MAY BE ISSUED DURING THE COURSE OF THE CONTRACT. ALL DISCREPANCIES SHALL BE REFERRED TO THE ARCHITECT AND ENGINEER BEFORE PROCEEDING WITH THE WORK.
- 9. ALL PIPES ARE TO BE MINIMUM Ø100mm uPVC STRAPPED TO UNDERSIDE OF SLAB U.N.O.
- 10. ALL PIPES ARE TO BE AT 1% MINIMUM GRADE U.N.O.
- 11. SLAB TO BE GRADED 1% TOWARDS PITS TO MEET REQUIREMENTS OF AS

FOR COORDINATION

B ISSUE FOR APPROVAL NV MS 31.03.2023
A ISSUE FOR COORDINATION NV MS 27.03.2023


Eng Draft Date

Rev Description


RE IRIS CAPITAL
LEVEL 41/264 GEORGE ST, SYDNEY NSW 2000



T: 02 8810 5800 E: info@xavierknight.com.au
A: Level 7, 210 Clarence Street, Sydney NSW 2000
xavierknight.com.au
This drawing is copyright and is the property of XAVIER KNIGHT CONSULTING ENGINEERS Pty. Ltd. and must not be used

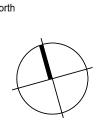

Project	Scale at A1	Drawn	Approved
EAST END STAGE 3 & 4 HUNTER, MORGAN, NEWCOMEN, KING STREET NEWCASTLE NSW 2300	1:200	MS	SS
Sheet Subject	Job No	Drawing No	Revision
STORMWATER MANAGEMENT PLAN STAGE 4S LOWER GROUND	220901	C107	В

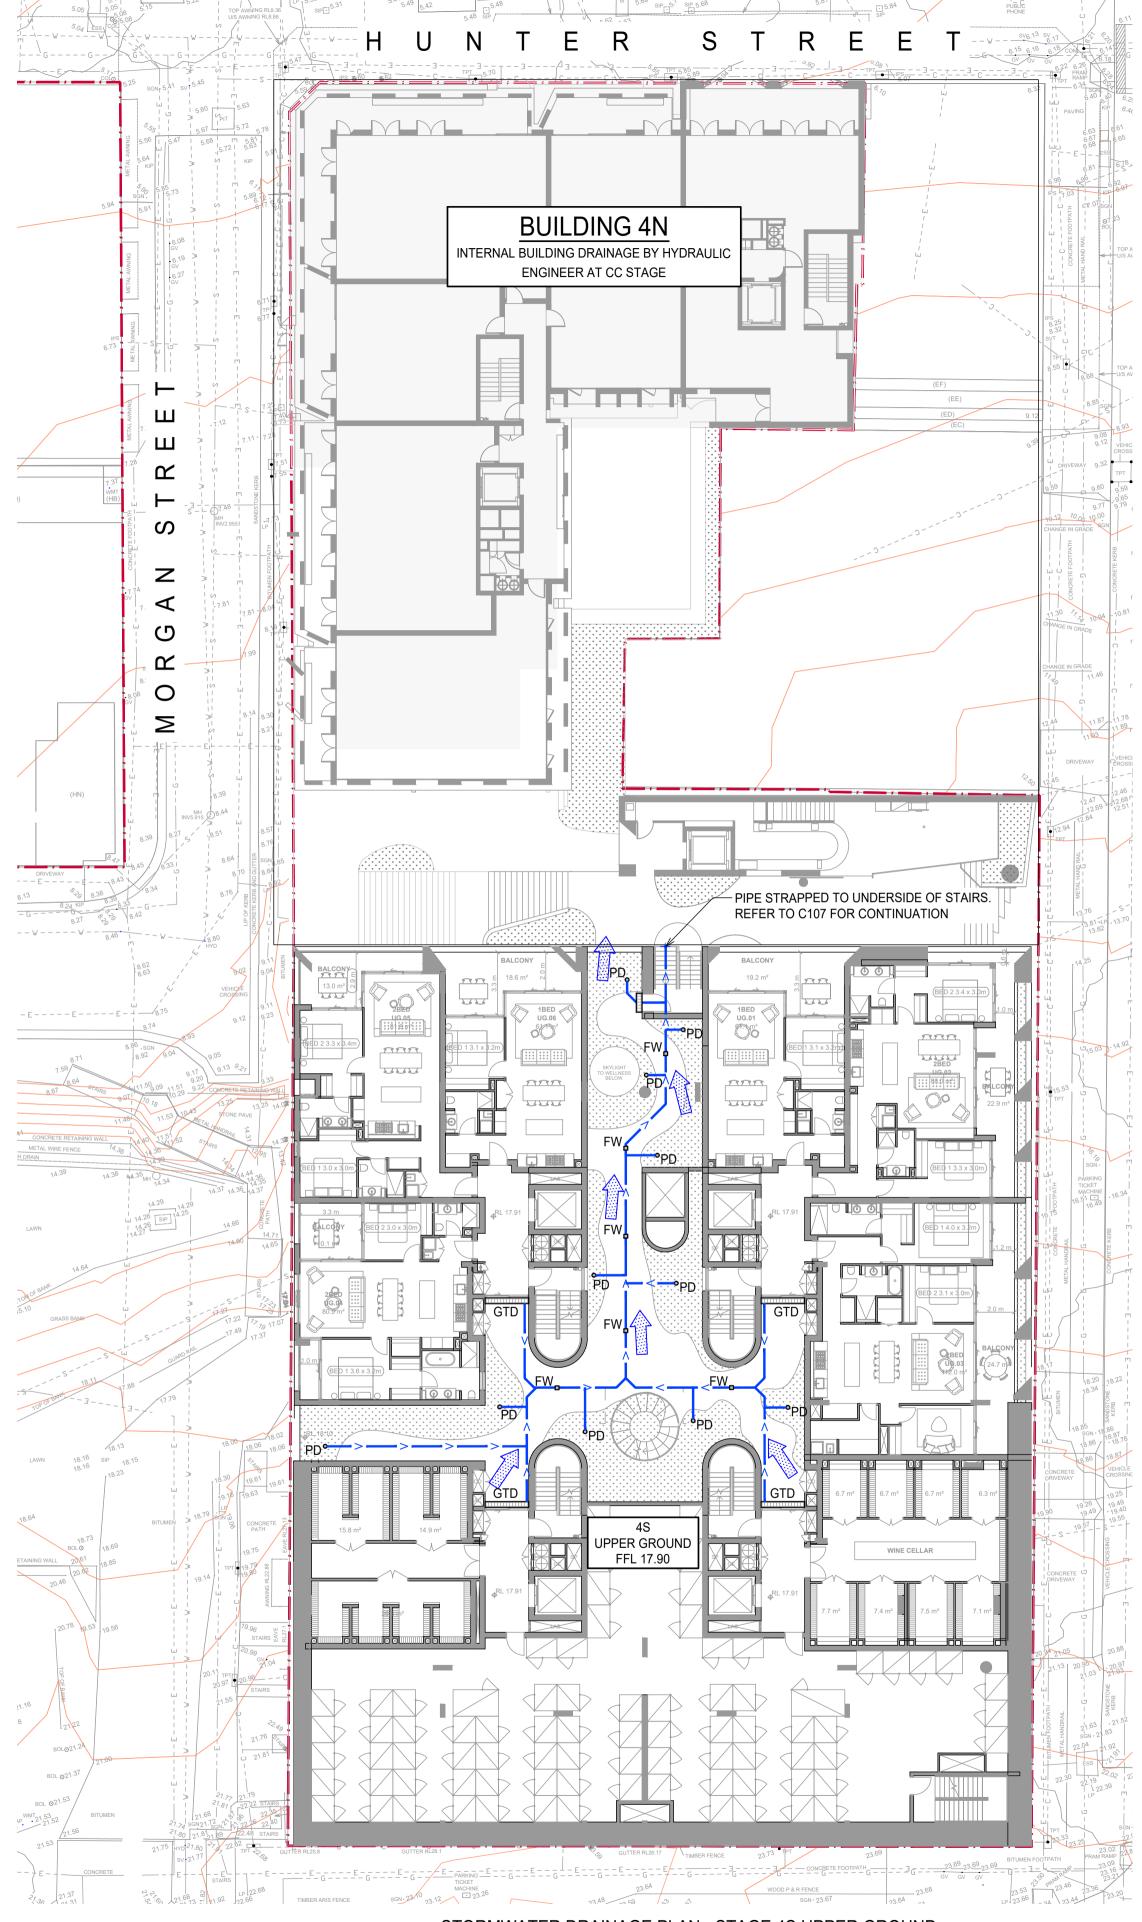

STORMWATER DRAINAGE PLAN - STAGE 4S UPPER GROUND SCALE 1:200

Architect SJB ARCHITECTURE LEVEL 2, 490 CROWN ST, SURRY HILLS, NSW

AA AA 31.03.2023

Eng Draft Date


A ISSUE FOR APPROVAL

Rev Description

IRIS CAPITAL LEVEL 41/264 GEORGE ST, SYDNEY NSW 2000



T : 02 8810 5800 E : info@xavierknight.com.au A : Level 7, 210 Clarence Street, Sydney NSW 2000 xavierknight.com.au This drawing is copyright and is the property of XAVIER KNIGHT CONSULTING ENGINEERS Pty. Ltd. and must not be used

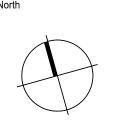

STAGE 4S UPPER GROUND

FOR APPROVAL Scale at A1 EAST END STAGE 3 & 4 SS 1:200 AAHUNTER, MORGAN, NEWCOMEN, KING STREET NEWCASTLE NSW 2300 Job No Drawing No Revision STORMWATER MANAGEMENT PLAN C108 220901

1. <u>GENERAL</u>

2. ALL DIMENSIONS AND ELEVATIONS SHOWN ON THE DRAWINGS ARE IN METRES (U.N.O.).

LEGEND

DP Ø

VD Ø

PD Ø

SWRM

FW ₪

PIT A02

RISING MAIN

SITE BOUNDARY

PROPOSED STORMWATER LINE

VALLEY LINE

PROPOSED GRATED DRAIN

OUTLINE OF LEVEL ABOVE

GRATED SURFACE INLET PIT

STORMWATER RISING MAIN

OVERLAND FLOW DIRECTION

SEALED JUNCTION PIT

DOWN PIPE OUTLET

VERTICAL DROP


PLANTER DRAIN

FLOOR WASTE


PIT TAG/NUMBER

FINISHED RL

- 3. SURVEY INFORMATION HAS BEEN OBTAINED FROM MONTHEAT & POWYS SURVEY TITLED "DETAIL SURVEY OF NEWCASTLE CBD AREA, HUNTER STREET, NEWCASTLE", REF. NO. 07/158, DATED 13/12/2007.
- 4. FUTURE PUBLIC DOMAIN STREET AND STORM DRAINAGE UPGRADE WORKS ON THORN STREET HAVE BEEN TAKEN FROM PLANS PREPARED BY NORTHROP UNDER THE PROJECT TITLED "HUNTER STREET MALL -STREETSCAPE REVITALISATION - DETAILED DESIGN - STAGE 2 - CIVIL ENGINEERING PACKAGE" AND APPROVED UNDER SECTION 138 OF THE ROADS ACT.
- FUTURE PUBLIC DOMAIN STREET AND STORM DRAINAGE UPGRADE WORKS ON HUNTER STREET HAVE BEEN TAKEN FROM PRELIMENARY PLANS PREPARED BY NORTHROP UNDER THE PROJECT TITLED "EAST END REDEVELOPMENT PROJECT - CONCEPT DESIGN - STAGES 3,4 6, 7 AND 8 -CIVIL ENGINEERING PACKAGE"
- 6. FUTURE PUBLIC DOMAIN STREET UPGRADE WORKS ON MORGAN AND LAING STREETS ARE SHOWN INDICATIVELY AND WILL FORM PART OF A FUTURE PACKAGE.
- 7. ALL WORKS IN THIS PACKAGE PROPOSED OUTSIDE THE LOT BOUNDARIES ARE SUBJECT TO S138 ROADS ACT APPROVAL.
- 8. THESE DRAWINGS SHALL BE READ IN CONJUNCTION WITH ALL ARCHITECTURAL AND OTHER CONSULTANTS' DRAWINGS AND SPECIFICATIONS AND WITH SUCH OTHER WRITTEN INSTRUCTIONS AS MAY BE ISSUED DURING THE COURSE OF THE CONTRACT. ALL DISCREPANCIES SHALL BE REFERRED TO THE ARCHITECT AND ENGINEER BEFORE PROCEEDING WITH THE WORK.
- 9. ALL PIPES ARE TO BE MINIMUM Ø100mm uPVC STRAPPED TO UNDERSIDE OF SLAB U.N.O.
- 10. ALL PIPES ARE TO BE AT 1% MINIMUM GRADE U.N.O.
- 11. SLAB TO BE GRADED 1% TOWARDS PITS TO MEET REQUIREMENTS OF AS

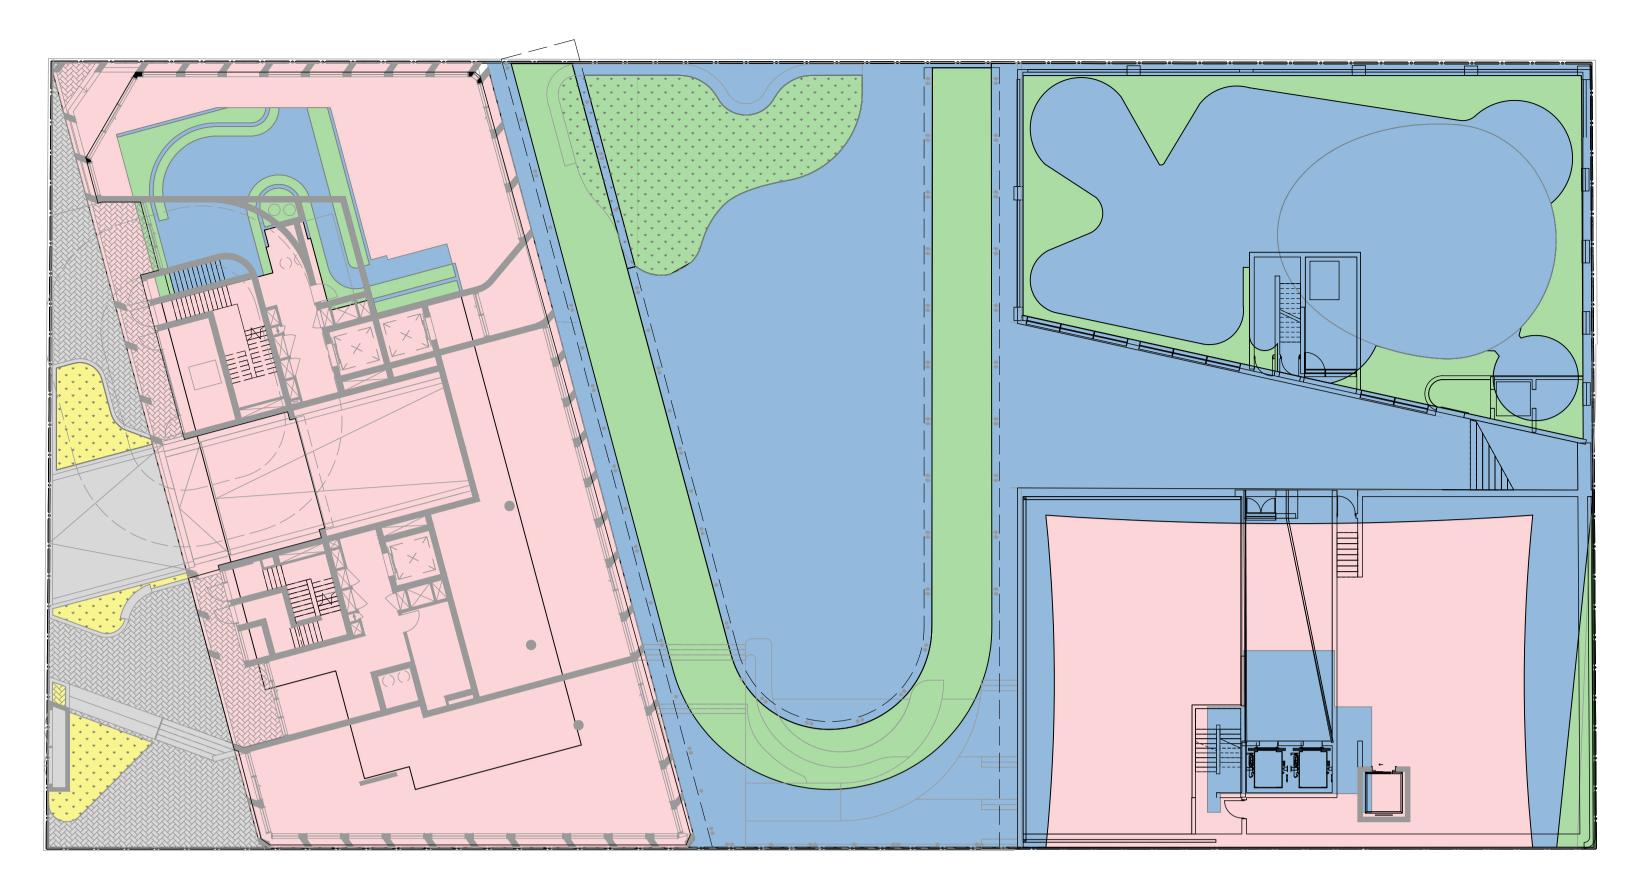

MUSIC CATCHMENT PLAN STAGE 3 SCALE 1:200

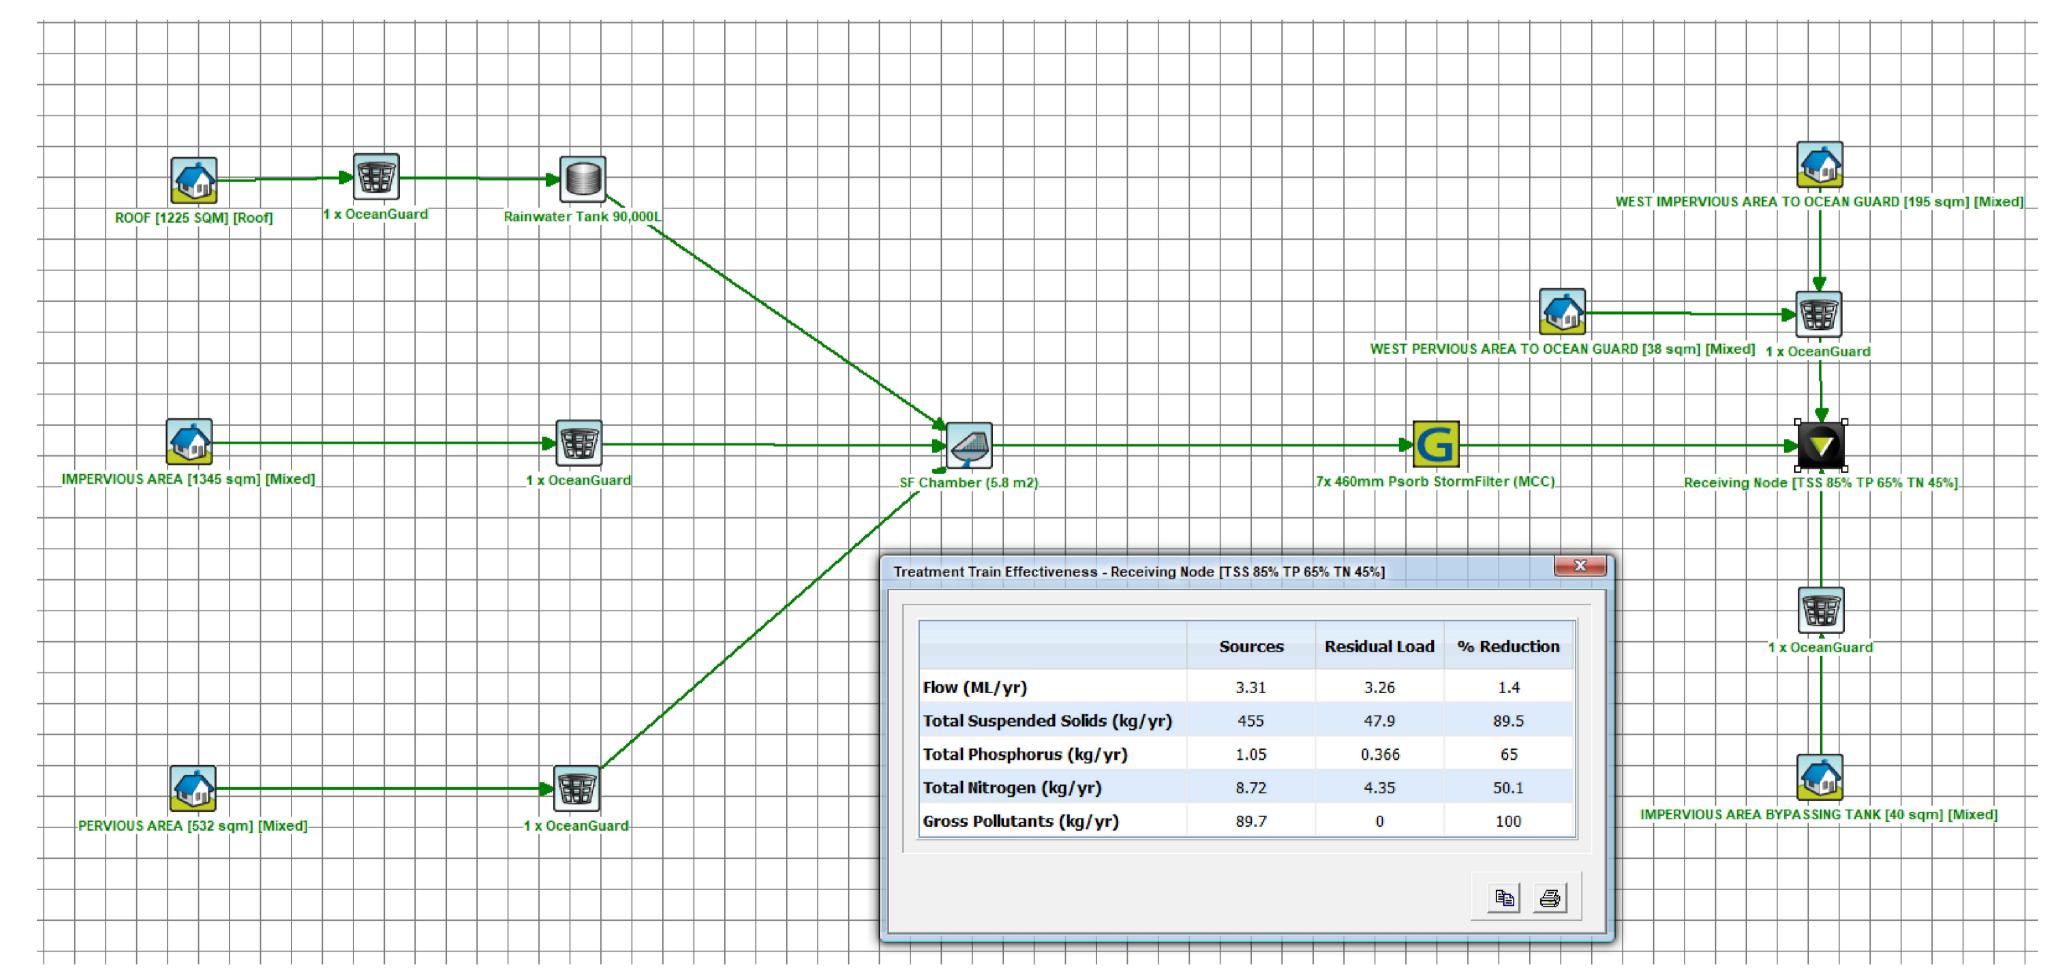

LEGEND

PERVIOUS LAND USE TO OCEAN GUARD AND WSUD CHAMBER (532 m²)

IMPERVIOUS LAND USE TO OCEAN GUARD AND WSUD CHAMBER (1385 m²)

ROOF LAND USE TO RWT AND WSUD CHAMBER (1225 m²)


IMPERVIOUS AREA TO OCEAN GUARD (195 m²)

PERVIOUS AREA TO OCEAN GUARD (38 m²)

FOR APPROVAL


	Architect	Client	1 1	N	North	Project	Scale at A1	Drawn	Approved
	SJB ARCHITECTURE LEVEL 2, 490 CROWN ST, SURRY HILLS, NSW	IRIS CAPITAL LEVEL 41/264 GEORGE ST, SYDNEY NSW 2000		T: 02 8810 5800 E: info@xavierknight.com.au A: Level 7, 210 Clarence Street, Sydney NSW 2000 xavierknight.com.au		EAST END STAGE 3 & 4 HUNTER, MORGAN, NEWCOMEN, KING STREET NEWCASTLE NSW 2300	NTS	NV	SS
	_ _			This drawing is copyright and is the property of XAVIER KNIGHT		Sheet Subject	Job No	Drawing No	Revision
A ISSUE FOR APPROVAL NV NV 31.03.202 Rev Description Eng Draft Date	<u>3</u>		KNIGHI	CONSULTING ENGINEERS Pty. Ltd. and must not be used without authorisation.		MUSIC CATCHMENT PLAN STAGE 3	220901	C170	Α



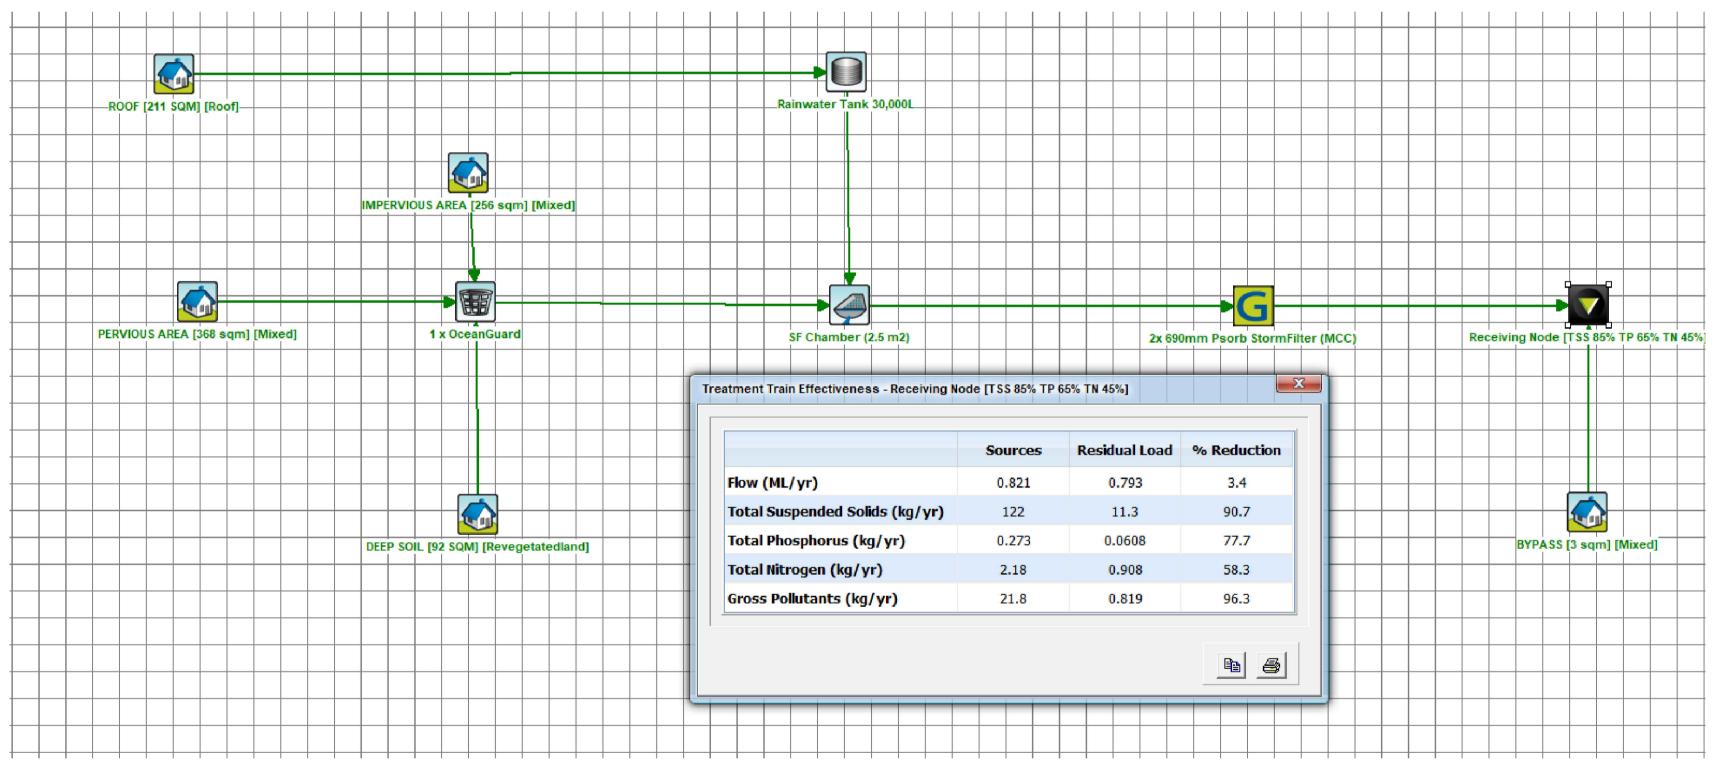

MUSIC CATCHMENT PLAN STAGE 4N SCALE 1:200

LEGEND

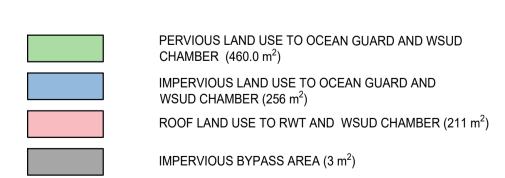


FOR APPROVAL

SS


Revision


Scale at A1 EAST END STAGE 3 & 4 T : 02 8810 5800 E : info@xavierknight.com.au A : Level 7, 210 Clarence Street, Sydney NSW 2000 IRIS CAPITAL SJB ARCHITECTURE NTS NV HUNTER, MORGAN, NEWCOMEN, KING STREET NEWCASTLE NSW 2300 LEVEL 2, 490 CROWN ST, SURRY HILLS, NSW LEVEL 41/264 GEORGE ST, SYDNEY NSW 2000 Sheet Subject Job No Drawing No This drawing is copyright and is the property of XAVIER KNIGHT CONSULTING ENGINEERS Pty. Ltd. and must not be used without authorisation. MUSIC CATCHMENT PLAN STAGE 4N 220901 C171 A ISSUE FOR APPROVAL NV NV 31.03.2023 Eng Draft Date Rev Description

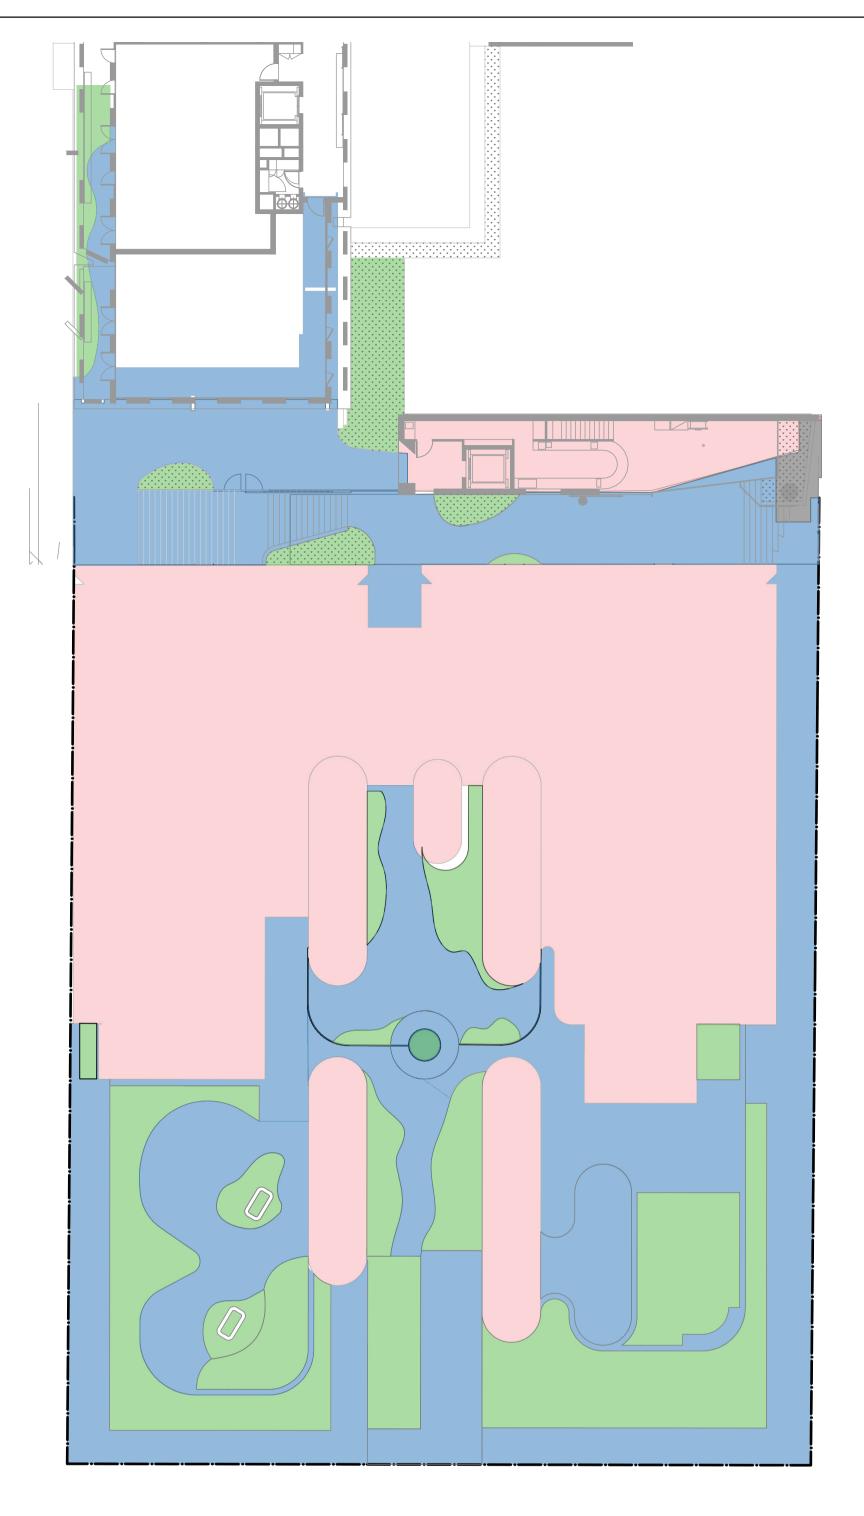



LEGEND

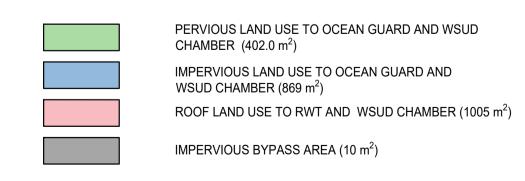

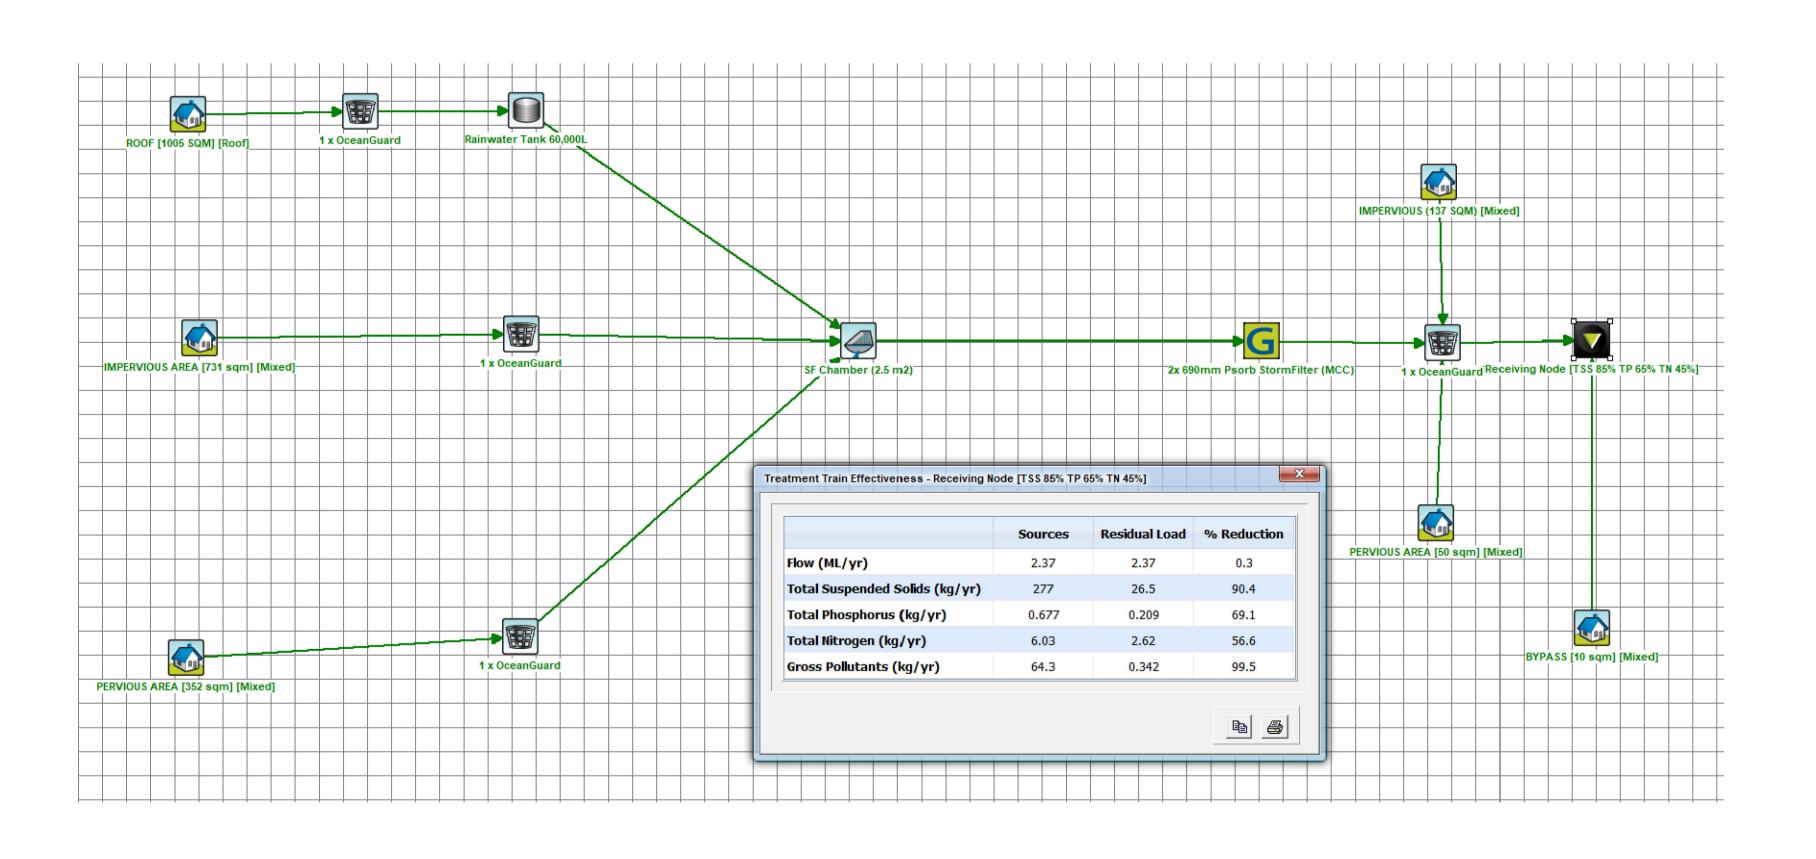

FOR APPROVAL

Architect
SJB ARCHITECTURE
LEVEL 2, 490 CROWN ST, SURRY HILLS, NSW

A ISSUE FOR APPROVAL
Rev Description
Rev Description

A ISSUE FOR APPROVAL
Rev Description

A ISSUE FOR APPROVAL
Rev Description

Architect
SJB ARCHITECTURE
LEVEL 2, 490 CROWN ST, SURRY HILLS, NSW

IRIS CAPITAL
LEVEL 41/264 GEORGE ST, SYDNEY NSW 2000

KIRLS CAPITAL
LEVEL 41/264 GEORGE ST, SYDNEY NSW 2000

KIRLS CAPITAL
LEVEL 41/264 GEORGE ST, SYDNEY NSW 2000


	Project	Scale at A1	Drawn	Appro
L-	EAST END STAGE 3 & 4 HUNTER, MORGAN, NEWCOMEN, KING STREET NEWCASTLE NSW 2300	1:200	NV	SS
)	Sheet Subject	Job No	Drawing No	Revis
	MUSIC CATCHMENT PLAN STAGE 4S	220901	C172	А

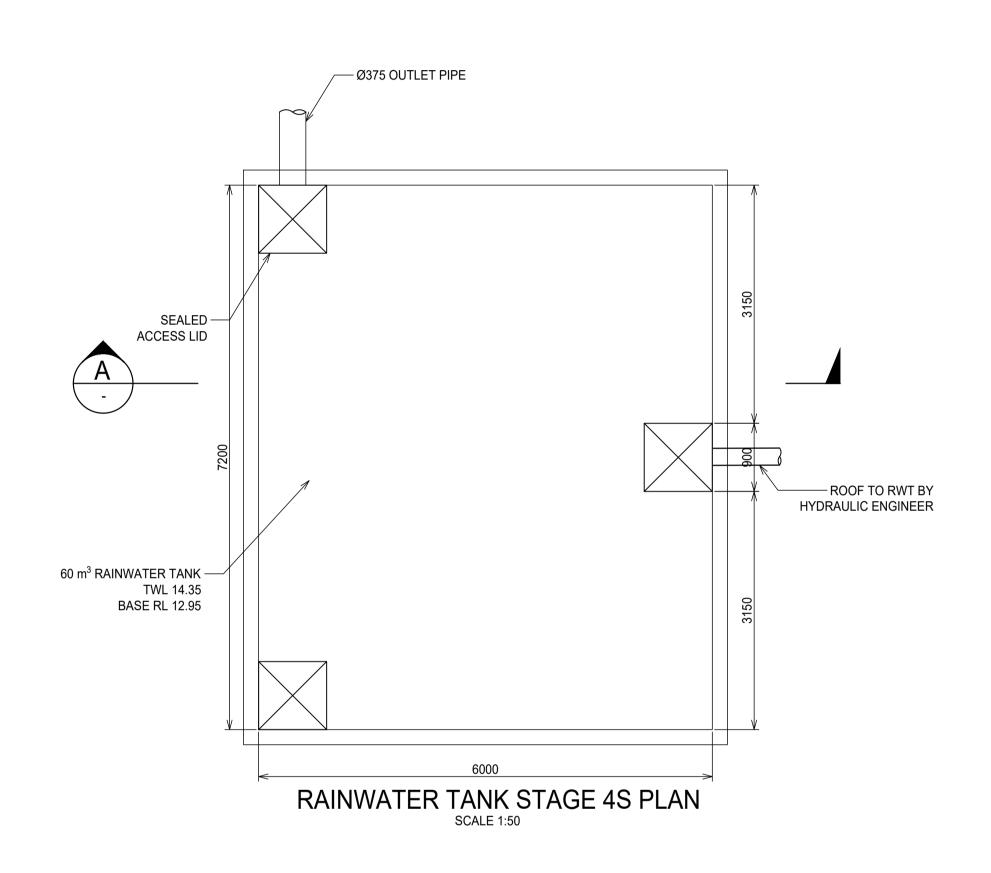

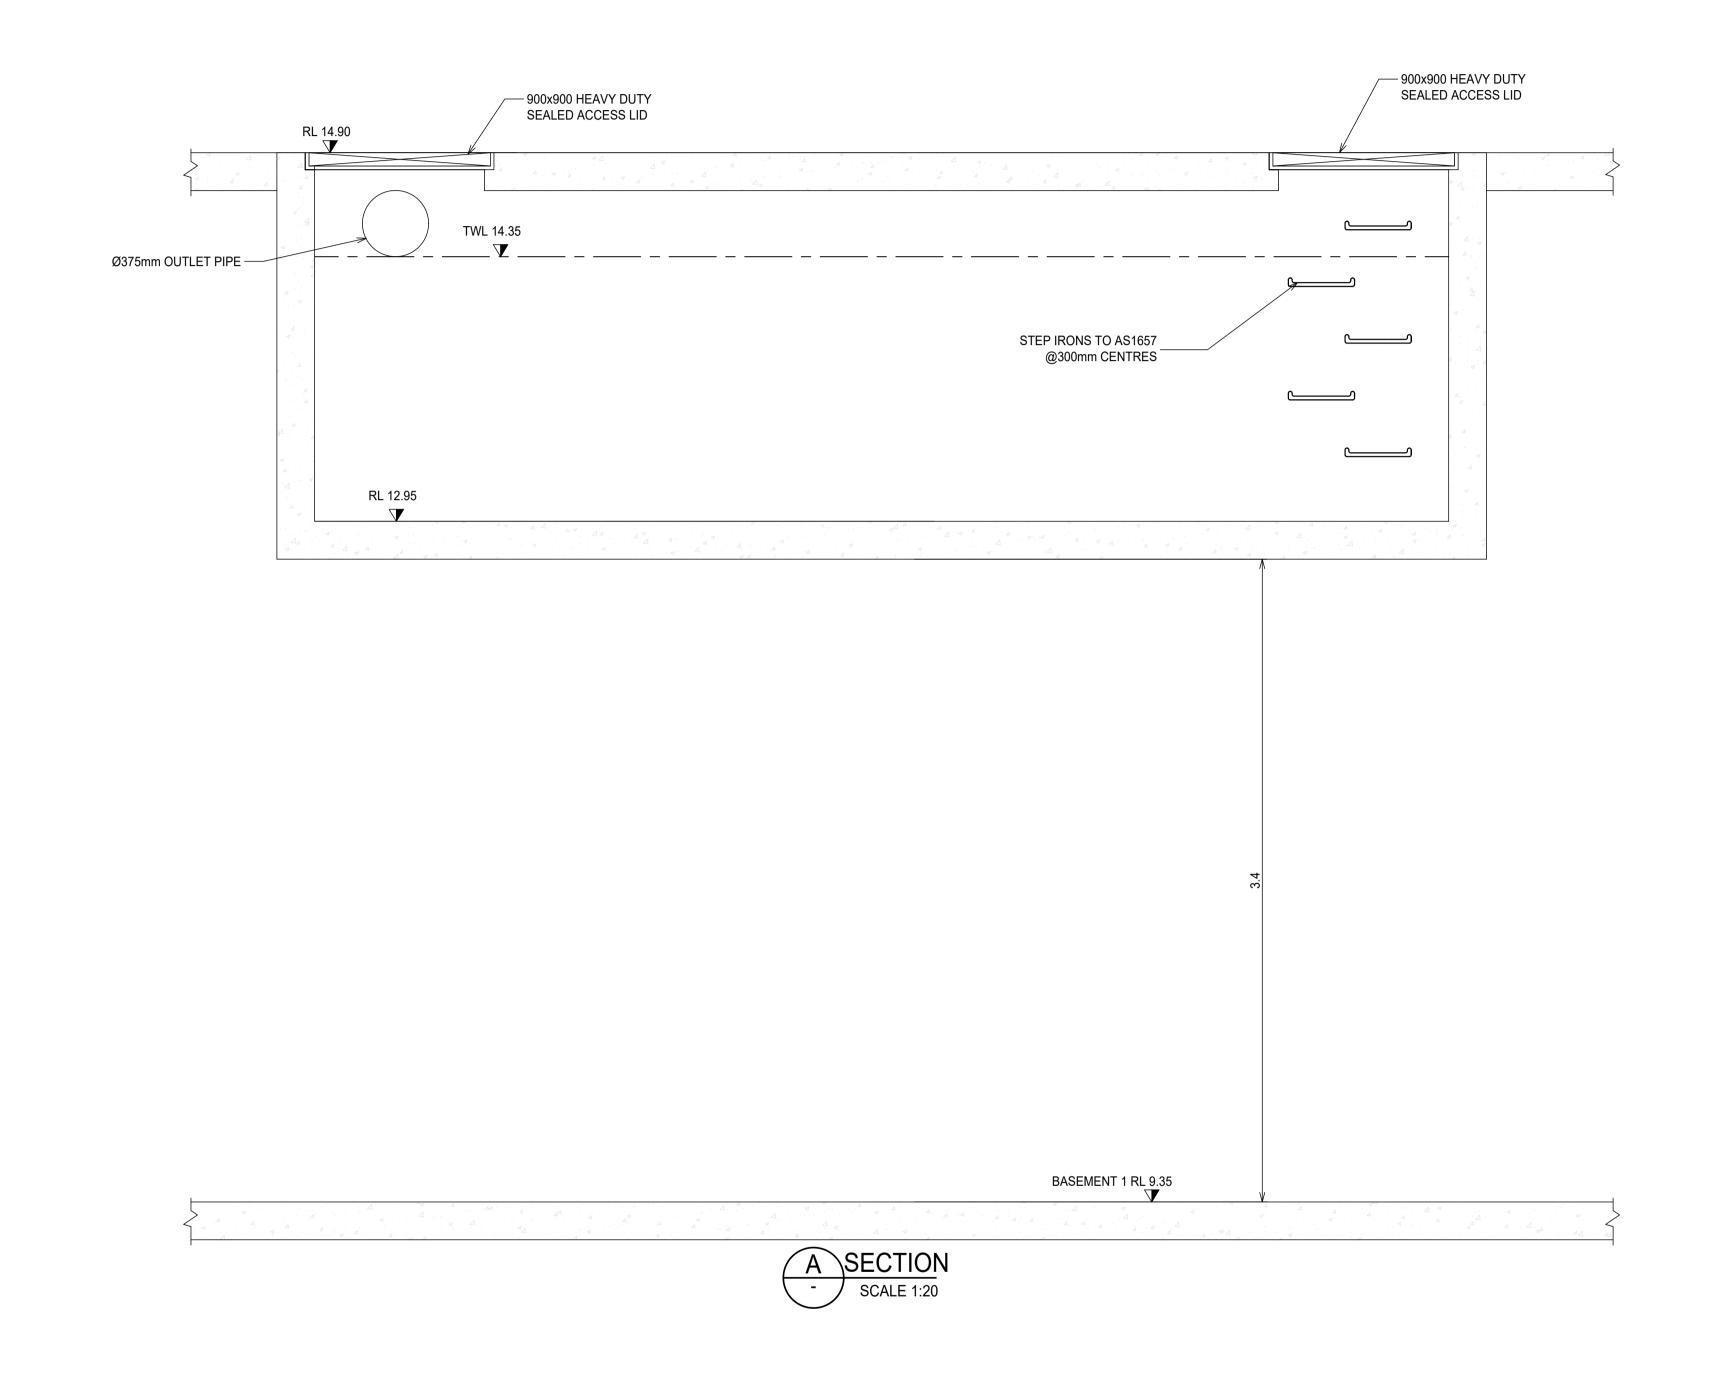


FOR APPROVAL


	Architect SJB ARCHITECTURE LEVEL 2, 490 CROWN ST, SURRY HILLS, NSW	IRIS CAPITAL LEVEL 41/264 GEORGE ST, SYDNEY NSW 2000	XAVIER T : 02 8810 5800 E : info@xavierknight.com.au A : Level 7, 210 Clarence Street, Sydney NSW 2000 xavierknight.com.au	North	Project EAST END STAGE 3 & 4 HUNTER, MORGAN, NEWCOMEN, KING STREET NEWCASTLE NSW 2300	Scale at A1 AS SHOWN	Drawn NV	Approved SS
B ISSUE FOR APPROVAL NV NV 31.03.202 A ISSUE FOR COORDINATION NV NV 27.03.202 Rev Description Eng Draft Date	<u> </u>		This drawing is copyright and is the property of XAVIER KNIGHT CONSULTING ENGINEERS Pty. Ltd. and must not be used without authorisation.		Sheet Subject STORMWATER DETAILS SHEET 01	Job No 220901	Drawing No	Revision A

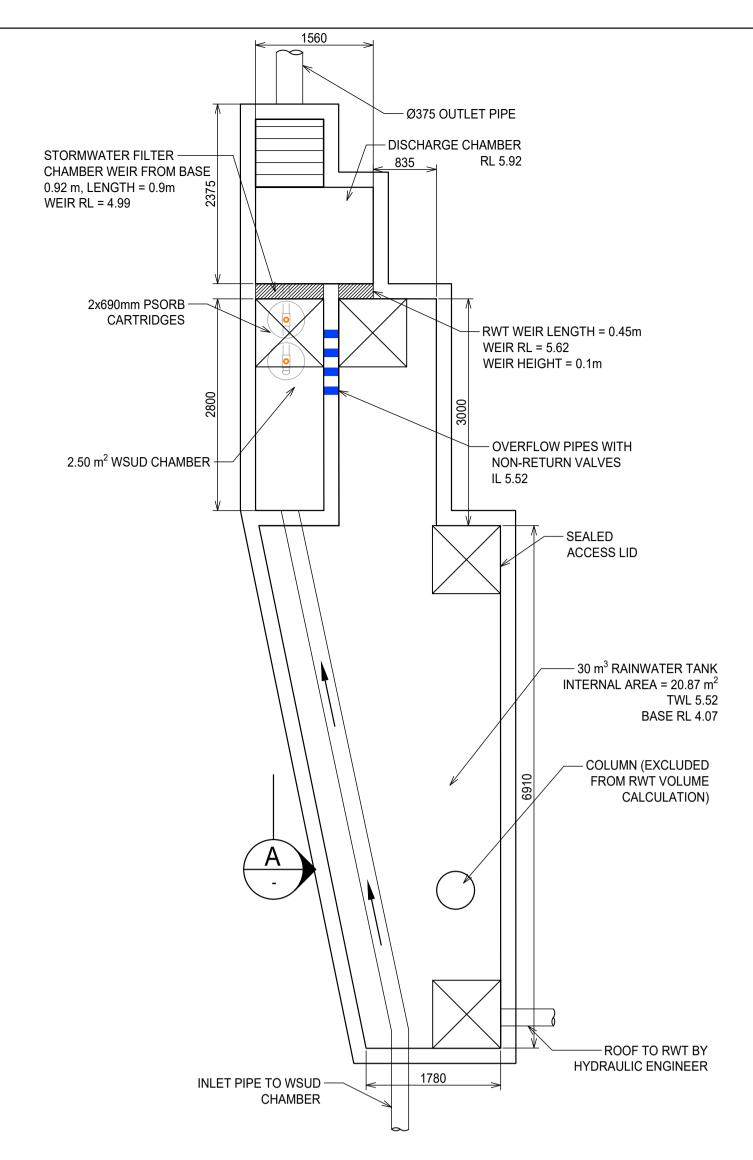


RAINWATER TANK/ WSUD CHAMBER 4N PLAN SCALE 1:50

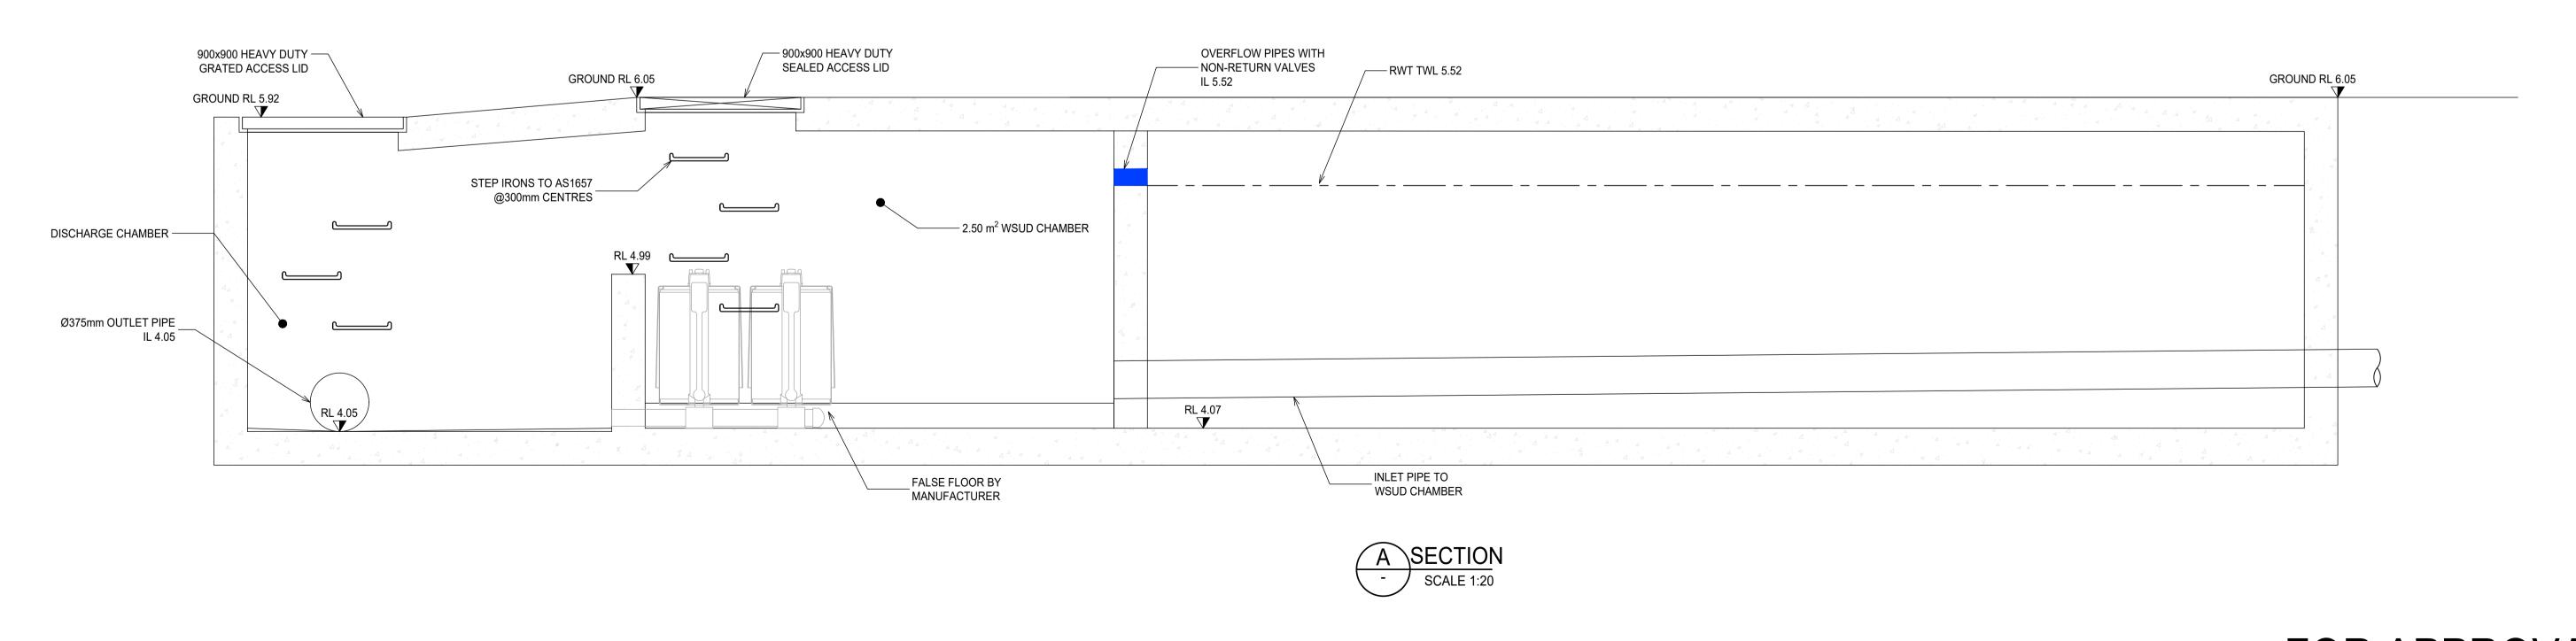


FOR APPROVAL Scale at A1 XAVIER EAST END STAGE 3 & 4 T : 02 8810 5800 E : info@xavierknight.com.au A : Level 7, 210 Clarence Street, Sydney NSW 2000 IRIS CAPITAL SJB ARCHITECTURE AS SHOWN SS NV HUNTER, MORGAN, NEWCOMEN, KING STREET NEWCASTLE NSW 2300 LEVEL 2, 490 CROWN ST, SURRY HILLS, NSW LEVEL 41/264 GEORGE ST, SYDNEY NSW 2000 Job No Drawing No This drawing is copyright and is the property of XAVIER KNIGHT CONSULTING ENGINEERS Pty. Ltd. and must not be used without authorisation. B ISSUE FOR APPROVAL NV NV 31.03.2023 STORMWATER DETAILS SHEET 02 220901 C201 NV NV 27.03.2023 A ISSUE FOR COORDINATION Eng Draft Date Rev Description

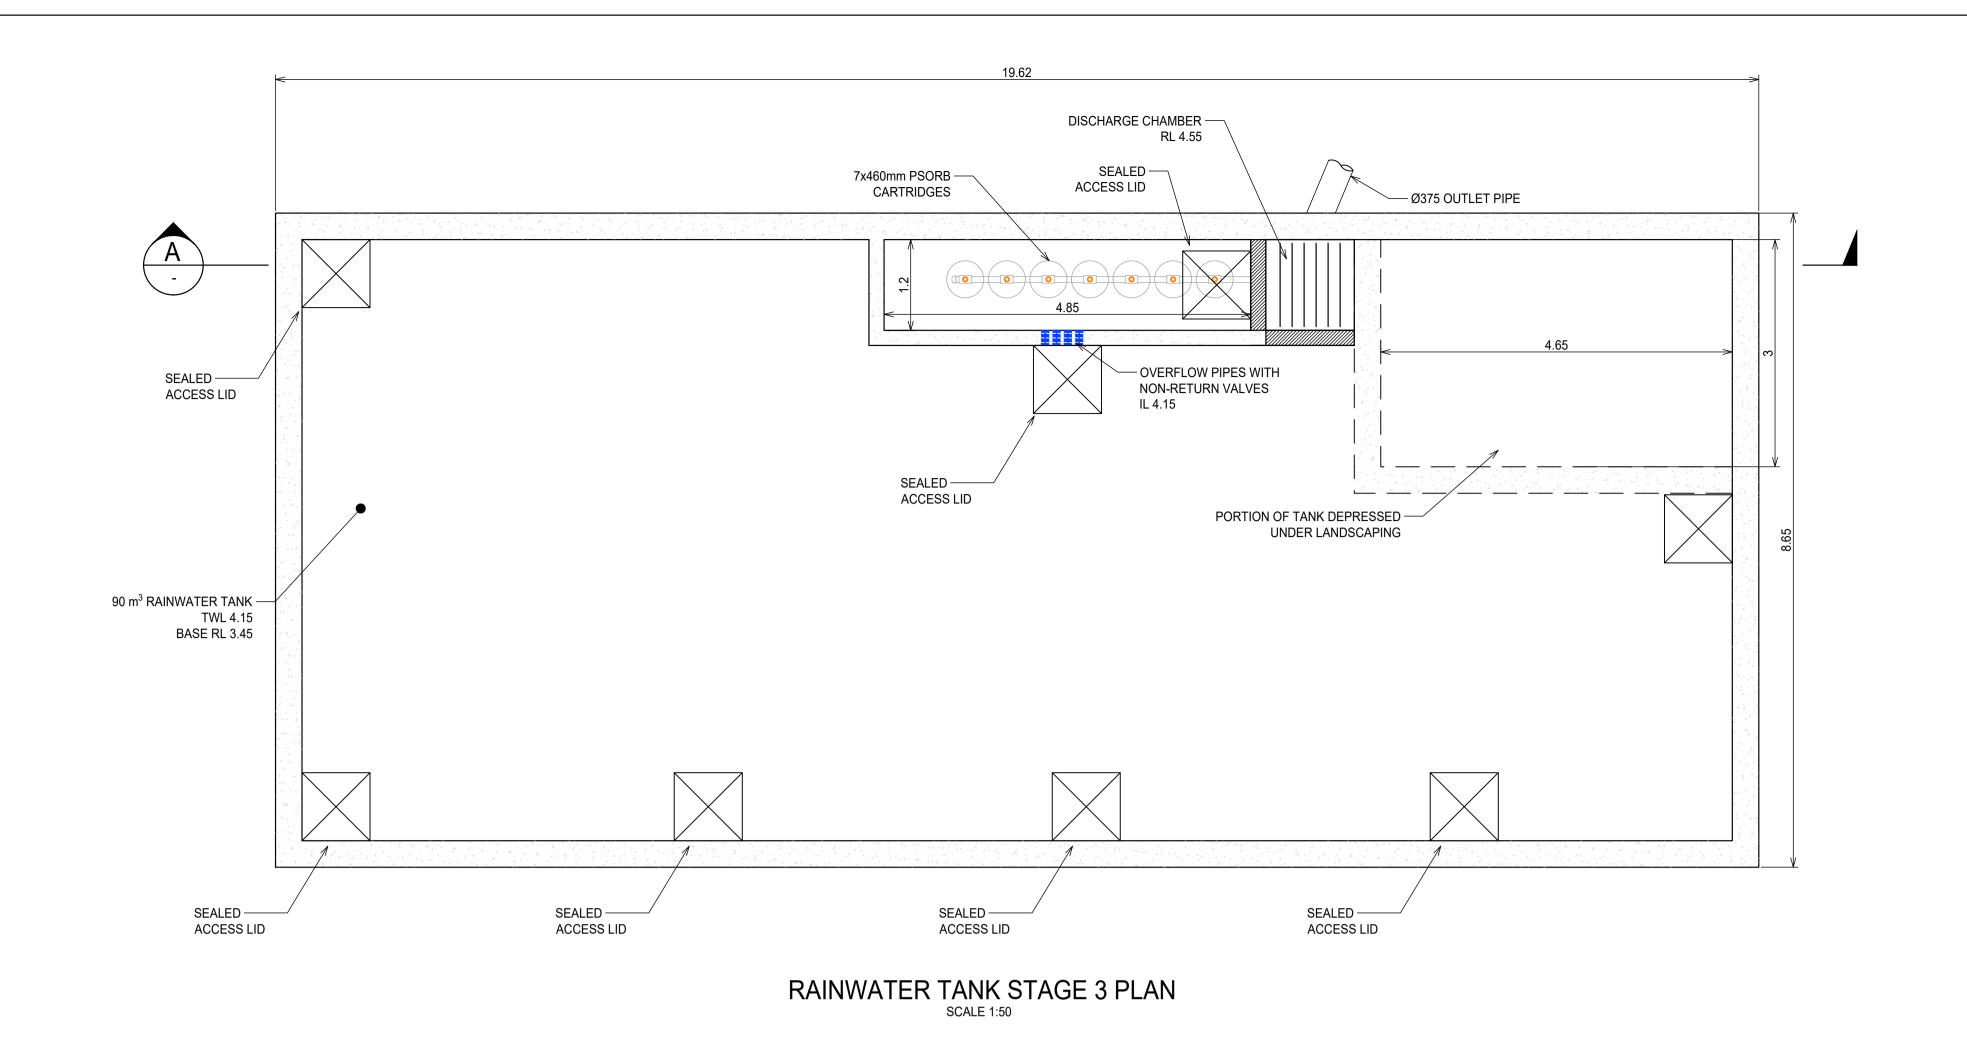


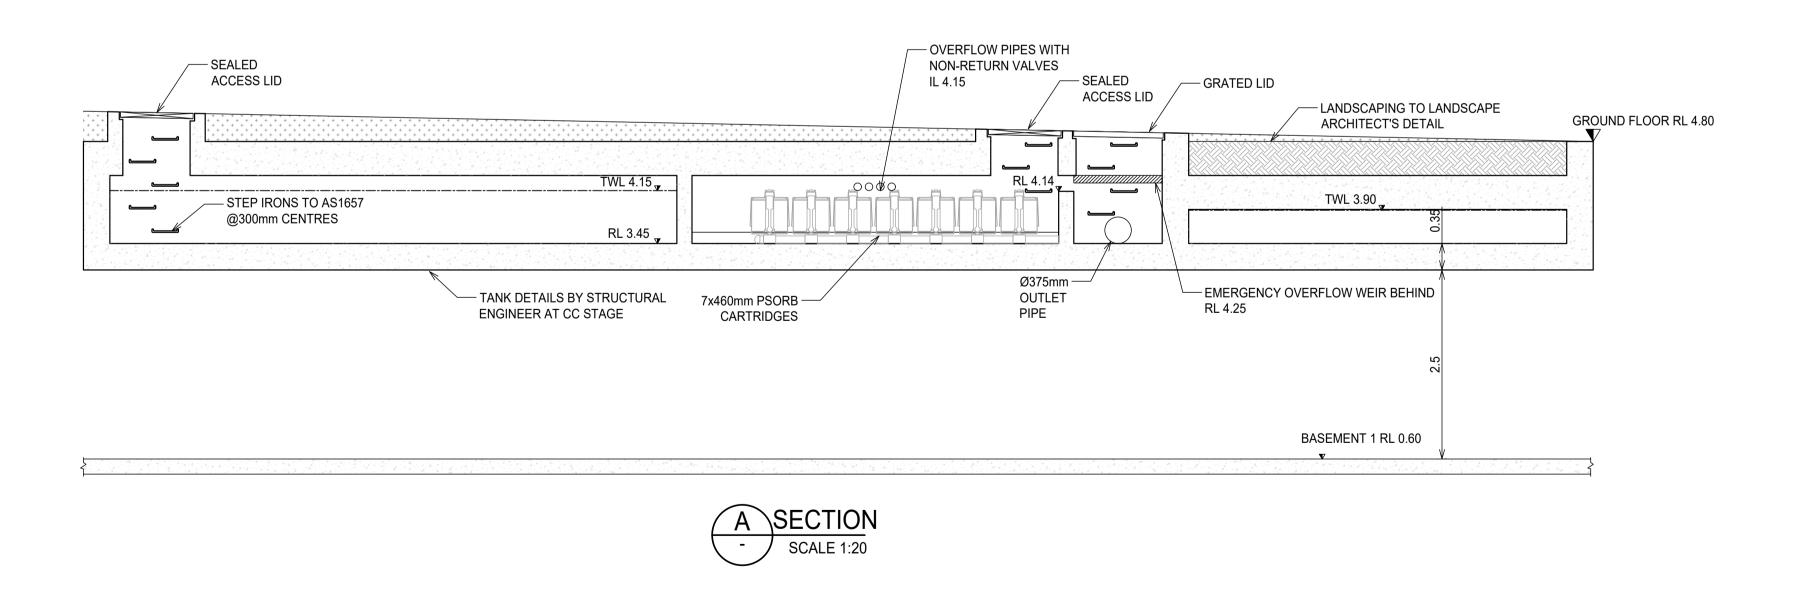


FOR APPROVAL

	Architect SJB ARCHITECTURE LEVEL 2, 490 CROWN ST, SURRY HILLS, NSW	Client IRIS CAPITAL LEVEL 41/264 GEORGE ST, SYDNEY NSW 2000	XAVIER T: 02 8810 5800 E: info@xavierknight.com.au A: Level 7, 210 Clarence Street, Sydney NSW 2000		EAST END STAGE 3 & 4 HUNTER, MORGAN, NEWCOMEN, KING STREET NEWCASTLE NSW 2300	Scale at A1 1:50	Drawn AA	Approved SS	
			KNIT	Xavierknight.com.au This drawing is copyright and is the property CONSULTING ENGINEERS Pty. Ltd. and m	of XAVIER KNIGHT nust not be used	Sheet Subject CTODMANATED DETAILS SHEET 02	Job No	Drawing No	Revision
A ISSUE FOR APPROVAL AA AA 31.03.2023 Rev Description Eng Draft Date				without authorisation.		STORMWATER DETAILS SHEET 03	220901	C202	A

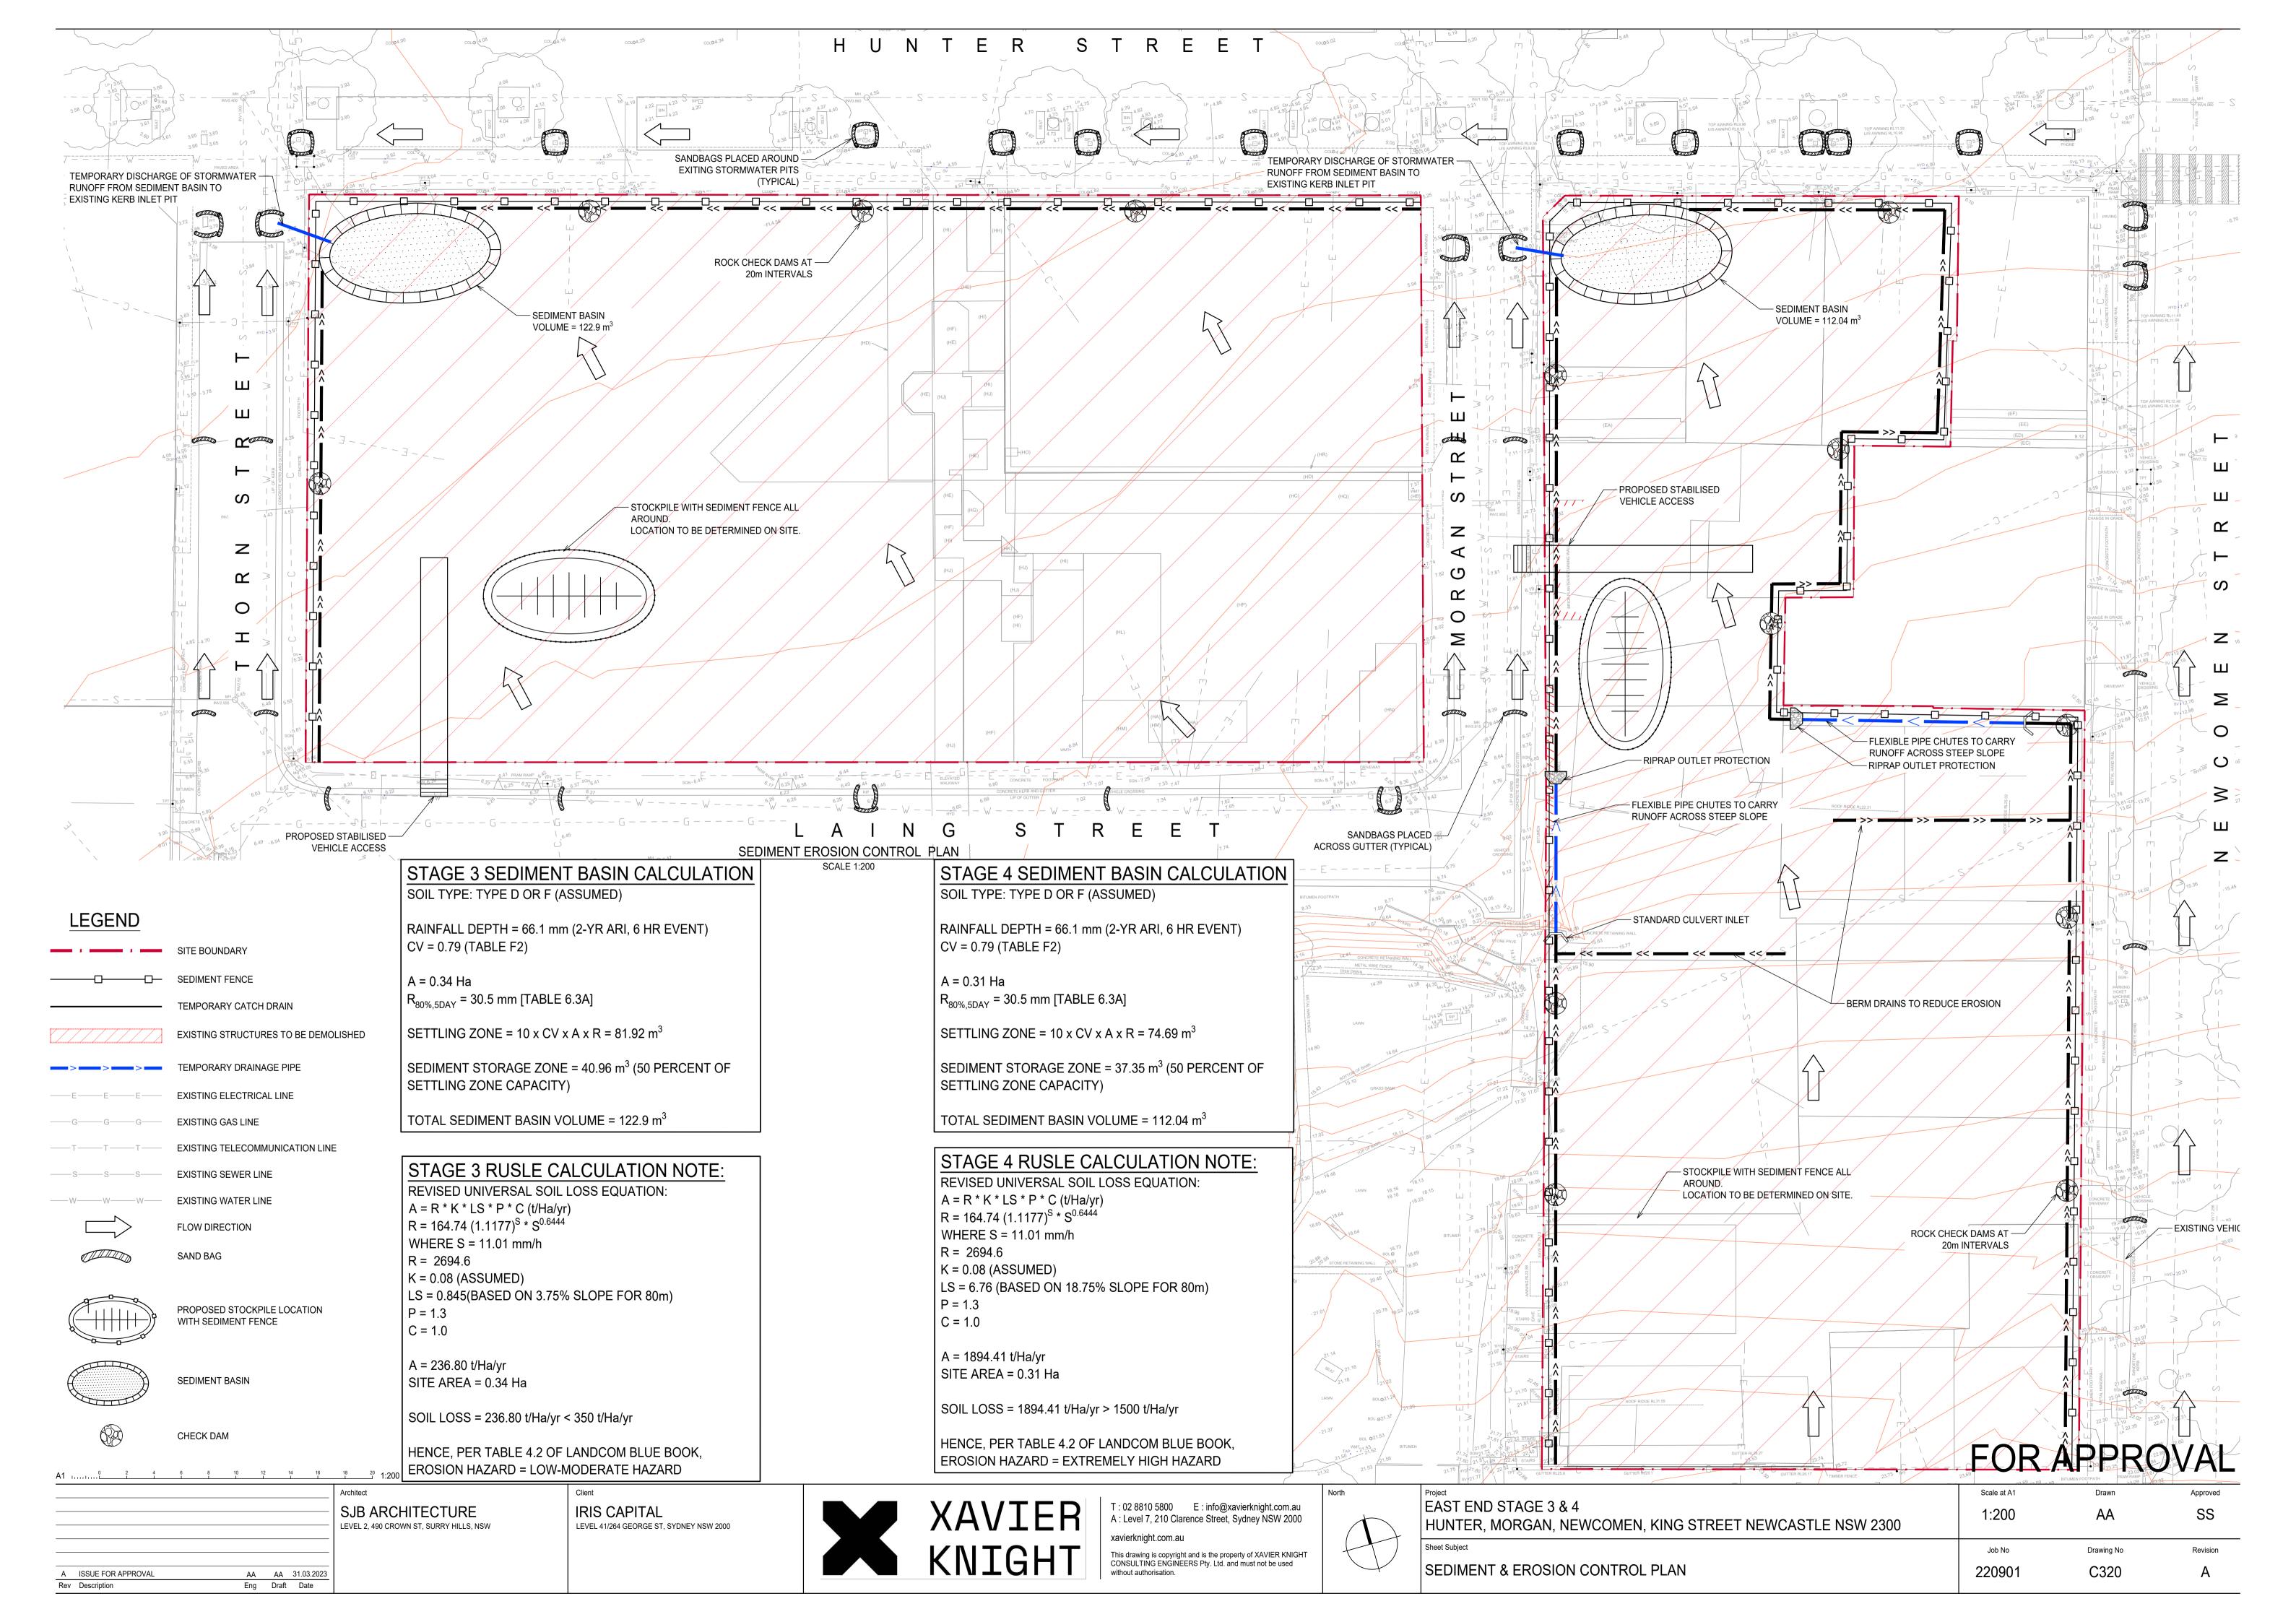

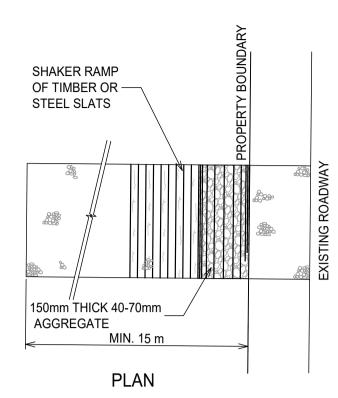


STABILISED SITE ACCESS WITH SHAKER RAMP

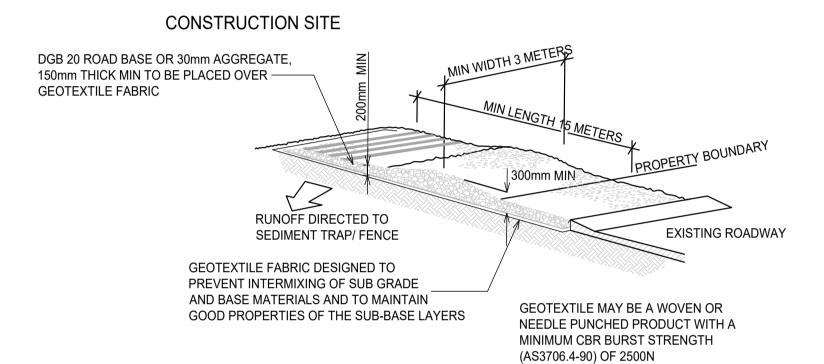


STABILISED SITE ACCESS WITH SHAKER RAMP


NOTES:

- . THIS DEVICE IS TO BE LOCATED AT ALL EXITS FROM CONSTRUCTION SITE.
- 2. THIS DEVICE IS TO BE REGULARLY CLEANED OF DEPOSITED MATERIAL SO AS TO MAINTAIN A 50mm DEEP SPACE BETWEEN PLANKS.
- 3. ANY UNSEALED ROAD BETWEEN THIS DEVICE AND NEAREST ROADWAY IS TO BE TOPPED WITH 100mm THICK 40-70mm SIZE AGGREGATE.
- 4. ALTERNATIVELY, THREE(3) PRECAST CONCRETE CATTLE GRIDS (AS MANUFACTURED BY "HUMES CONCRETE MAY BE USED. 1, 2 & 3 ABOVE ALSO APPLY

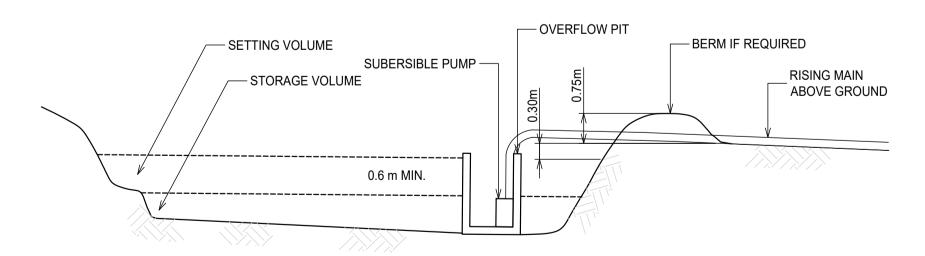


TYPICAL SEDIMENT BASIN SCALE N.T.S.

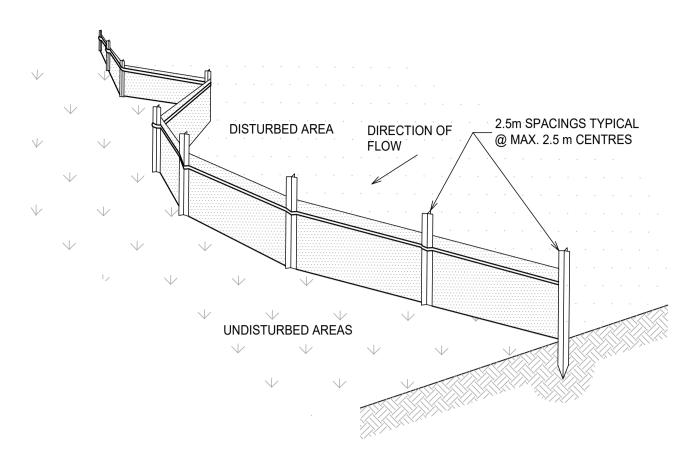


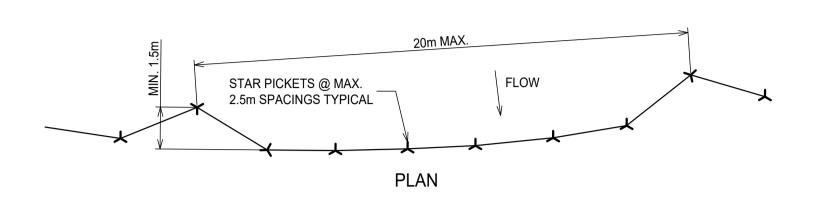

SEDIMENT FENCE

SCALE N.T.S.

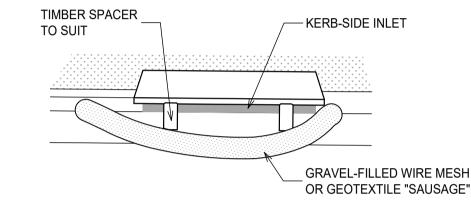

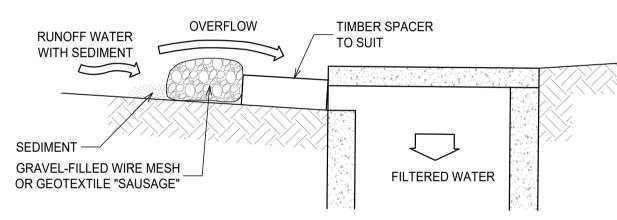

MESH & GRAVEL INLET FILTER CONSTRUCTION NOTES:


SEDIMENT / LADEN WATERS CANNOT PASS BETWEEN.

- 1. FABRICATE A SLEEVE MADE FROM GEOTEXTILE OR WIRE MESH LONGER THAN THE LENGTH OF THE INLET PIT AND FILL IT WITH 25mm TO 50mm GRAVEL.
- FORM AN ELLIPTICAL CROSS-SECTION ABOUT 150mm HIGH x 400mm WIDE.

 PLACE THE FILTER AT THE OPENING LEAVING AT LEAST A 100mm SPACE BETWEEN IT
- AND THE KERB INLET. MAINTAIN THE OPENING WITH SPACER BLOCKS.
- FORM A SEAL WITH THE KERB TO PREVENT SEDIMENT BYPASSING THE FILTER.
 SANDBAGS FILLED WITH GRAVEL CAN SUBSTITUTE FOR THE MESH OR GEOTEXTILE PROVIDING THEY ARE PLACED SO THAT THEY CAN FIRMLY ABUT EACH OTHER AND

MESH & GRAVEL INLET FILTER

SCALE N.T.S.

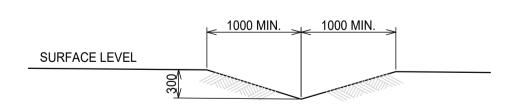

TYPICAL SECTION THROUGH CATCH DRAIN

NOTE:
REFER TO PROPOSED CONTOURS FOR EXACT PROFILE OF


CATCH DRAIN REQUIRED IN FINAL STATE

NOTES:


- PROVIDE THREE LAYERS OF SANDBAGS WITH THEIR ENDS OVERLAPPED AND ALSO OVERLAPPING ONTO THE KERB.
- 2. CREATE A GAP IN THE SANDBAGS TO ACT AS A SPILLWAY.
- 3. SANDBAG BARRIER TO BE MIN. 2m FROM THE INLET AND EXTEND MIN. 0.9m OUT FROM THE KERB.

GULLY INLET SANDBAG PROTECTION DETAIL

SCALE N.T.S.

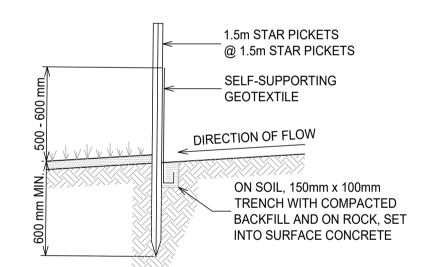

SECTION DETAIL

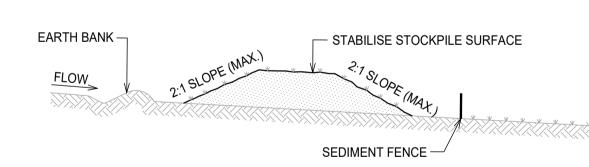

STOCKPILE CONSTRUCTION NOTES:

North

- 1. PLACE STOCKPILES MORE THAN 2 (PREFERABLY 5) METRES FROM EXISTING VEGETATION, CONCENTRATED WATER FLOW, ROADS AND HAZARD AREAS.
- 2. CONSTRUCT ON THE CONTOUR AS LOW, FLAT, ELONGATED MOUNDS.

 3. WHERE THERE IS SUFFICIENT AREA TOPSOU STOCKPILES SHALL BE LES
- 3. WHERE THERE IS SUFFICIENT AREA, TOPSOIL STOCKPILES SHALL BE LESS THAN 2 METRES IN HEIGHT.
- 4. WHERE THEY ARE TO BE PLACED FOR MORE THAN 10 DAYS, STABILISE FOLLOWING THE APPROVED E.S.C.P. OR S.W.M.P. TO REDUCE THE C-FACTOR TO LESS THAN 0.10.
- CONSTRUCT EARTH BANKS ON THE UPSLOPE SIDE TO DIVERT WATER AROUND STOCKPILES AND SEDIMENT FENCES 1 TO 2 METRES DOWNSLOPE.

STOCKPILES SCALE N.T.S.

SEDIMENT FENCE CONSTRUCTION NOTES:

- 1. CONSTRUCT SEDIMENT FENCES AS CLOSE AS POSSIBLE TO BEING PARALLEL TO THE CONTOURS OF THE SITE, BUT WITH SMALL RETURNS AS SHOWN IN THE DRAWING TO LIMIT THE CATCHMENT AREA OF ANY ONE SECTION. THE CATCHMENT AREA SHOULD BE SMALL ENOUGH TO LIMIT WATER FLOW IF CONCENTRATED AT ONE POINT TO 50 LITRES PER SECOND IN THE DESIGN STORM EVENT, USUALLY THE 10-YEAR EVENT.
- 2. CUT A 150 mm DEEP TRENCH ALONG THE UPSLOPE LINE OF THE FENCE FOR THE BOTTOM OF THE FABRIC TO BE ENTRENCHED.
- 3. DRIVE 1.5 m LONG STAR PICKETS INTO GROUND @ 2.5 m INTERVALS (MAX.) AT THE DOWNSLOPE EDGE OF THE TRENCH. ENSURE ANY STAR PICKETS ARE FITTED WITH SAFETY CAPS.
- 4. FIX SELF-SUPPORTING GEOTEXTILE TO THE UPSLOPE SIDE OF THE POSTS ENSURING IT GOES TO THE BASE OF THE TRENCH. FIX THE GEOTEXTILE WITH WIRE TIES OR AS RECOMMENDED BY THE MANUFACTURER. ONLY USE GEOTEXTILE SPECIFICALLY PRODUCED FOR SEDIMENT FENCING. THE USE OF SHADE CLOTH FOR THIS PURPOSE IS NOT SATISFACTORY.
- 5. JOIN SECTIONS OF FABRIC AT A SUPPORT POST WITH A 150 mm OVERLAP.
- 6. BACKFILL THE TRENCH OVER THE BASE OF THE FABRIC AND COMPACT IT THOROUGHLY OVER THE GEOTEXTILE.

GENERAL INSTRUCTIONS:


- THIS SOIL AND WATER MANAGEMENT WORKS FOR THE SITE SHALL BE CARRIED OUT IN ACCORDANCE WITH THE REQUIREMENTS OF "MANAGING URBAN STORMWATER - SOILS AND CONSTRUCTION, 4TH EDITION (2004)" BY LANDCOM.
- 2. AS REQUIRED BY COUNCIL, SEDIMENT CONTROL MEASURES WILL BE REQUIRED DURING THE CONSTRUCTION OF ALL DEVELOPMENTS/BUILDING WORKS. IT SHALL BE THE CONTRACTOR'S RESPONSIBILITY THAT THE WORKS ARE CARRIED OUT IN ACCORDANCE WITH THE SOIL ANAD WATER MANAGEMENT PLAN AND COUNCIL'S REQUIREMENTS.
- THE CONTRACTOR SHALL ENSURE THAT ALL SUBCONTRACTORS ARE INFORMED OF THEIR RESPONSIBILITIES IN MINIMISING THE POTENTIAL FOR SOIL EROSION AND POLLUTION TO DOWNSLOPE AREAS.
- 4. THE NON-DISTURBED PORTION OF THE CATCHMENT OUTSIDE OF OPERATING AREA IS TO BYPASS THE BASINS BY MEANS OF LINED CATCH DRAINS.
- 5. WHERE PRACTICABLE, THE SOIL EROSION HAZARD SHALL BE KEPT AS LOW AS POSSIBLE. LIMITATIONS TO ACCESS ARE TO BE VIA STANLEY LANE UNLESS OTHERWISE APPROVED BY COUNCIL.
- ENSURE THAT ALL DRAINS ARE OPERATING EFFECTIVELY AND SHALL MAKE ANY NECESSARY REPAIRS. REMOVE TRAPPED SEDIMENT WHERE THE CAPACITY OF THE TRAPPING DEVICE FALLS BELOW 60%.
- 7. CONSTRUCT ADDITIONAL EROSION OR SEDIMENT CONTROL WORKS AS MAY BE APPROPRIATE TO ENSURE THE PROTECTION OF DOWNSLOPE LANDS AND WATERWAYS.
- MAINTAIN EROSION AND SEDIMENT CONTROL MEASURES IN A FULLY FUNCTIONING CONDITION AT ALL TIMES UNTIL THE SITE IS REHABILITATED.
- REMOVE TEMPORARY SOIL CONSERVATION STRUCTURES AS THE LAST ACTIVITY IN THE REHABILITATION PROGRAM.

CONSTRUCTION SEQUENCE:

WORKS SHALL BE UNDERTAKEN IN THE FOLLOWING SEQUENCE:

- 1. INSTALL SEDIMENT FENCING AND CUT DRAINS TO MEET THE REQUIREMENTS OF THE SOIL AND WATER MANAGEMENT PLAN. WASTE COLLECTION BINS SHALL BE INSTALLED ADJACENT TO SITE OFFICE.
- 2. CONSTRUCT STABILISED SITE ACCESS IN ACCORDANCE WITH COUNCIL'S REQUIREMENTS.
- 3. REDIRECT CLEAN WATER AROUND THE CONSTRUCTION SITE.
- 4. INSTALL SEDIMENT CONTROL PROTECTION MEASURES AT ALL NATURAL AND MAN-MADE DRAINAGE STRUCTURES. MAINTAIN UNTIL ALL THE DISTURBED AREAS ARE STABILISED.
- 5. CLEAR AND STRIP THE WORK AREAS. MINIMISE THE DAMAGE TO THE GRASS AND LOW GROUND COVER OF NON-DISTURBED AREAS.
- 6. ANY DISTURBED AREAS, OTHER THAN BUILDING PAD AREAS, SHALL IMMEDIATELY BE COVERED WITH SITE TOPSOIL WITHIN 7 DAYS OF CLEARING. BUILDING PAD AREAS SHALL BE COVERED WITH BITUMEN EMULSION AS SPECIFIED.
- 7. APPLY PERMANENT STABILISATION TO SITE (LANDSCAPING).

FOR APPROVAL

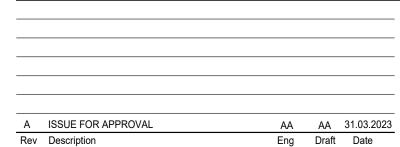

SJB ARCHITECTURE
LEVEL 2, 490 CROWN ST, SURRY HILLS, NSW

IRIS CAPITAL
LEVEL 41/264 GEORGE ST, SYDNEY NSW 2000



T: 02 8810 5800 E: info@xavierknight.com.au
A: Level 7, 210 Clarence Street, Sydney NSW 2000
xavierknight.com.au

This drawing is copyright and is the property of XAVIER KNIGHT CONSULTING ENGINEERS Pty. Ltd. and must not be used without authorisation

Project	Scale at A1	Drawn	Approved
EAST END STAGE 3 & 4 HUNTER, MORGAN, NEWCOMEN, KING STREET NEWCASTLE NSW 2300	NTS	AA	SS
Sheet Subject	Job No	Drawing No	Revision
SEDIMENT & EROSION CONTROL DETAILS	220901	C350	Α